
SECTION 01 11 00

SUMMARY OF WORK

PART 1 - GENERAL

1.1 SECTION INCLUDES

- A. Work Included.
- B. Work by Owner.
- C. Owner furnished products.
- D. Contractor use of site and premises.
- E. Owner occupancy.
- F. Work restrictions.

1.2 WORK INCLUDED

- A. Work of this Contract comprises general construction including remodeling of
Ravenswood Middle School Building A, Locker Areas, Music Room, Related Spaces and
Associated Site Work located at 2450 Ralmar Avenue, East Palo Alto, CA 94303 for The
Ravenswood City School District, Owner.
- B. Construct the work under a single lump sum contract.

1.3 WORK BY OWNER

- A. Items noted "NIC" (Not In Contract) will be furnished and installed by Owner.
 - 1. None.
- B. Owner will remove and retain possession of the following items prior to start of work:
 - 1. Televisions
 - 2. White Boards
 - 3. A/V Speakers
- C. Contractor will remove and Owner will take possession of the following items prior to
start of work:
 - 1. Door hardware
 - 2. Metal Doors

1.4 OWNER FURNISHED PRODUCTS

- A. Items noted "OFCI" (Owner-Furnished Contractor Installed) will be furnished by Owner and installed by Contractor.
- B. Items noted "OFOI" (Owner-Furnished Owner Installed) will be furnished by Owner and installed by Owner.
- C. Owner's Responsibilities:
 - 1. Arrange for and deliver Owner reviewed Shop Drawings, Product Data, and Samples to Contractor.
 - 2. Arrange and pay for Product delivery to site.
 - 3. On delivery, inspect Products jointly with Contractor.
 - 4. Submit claims for transportation damage and replace damaged, defective, or deficient items.
 - 5. Arrange for manufacturer's warranties, inspections, and service.
- D. Contractor's Responsibilities:
 - 1. Review Owner reviewed Shop Drawings, Product Data, and Samples.
 - 2. Receive and unload Products at site; inspect for completeness or damage, jointly with Owner.
 - 3. Handle, store, install and finish Products.
 - 4. Repair or replace items damaged after receipt.
- E. Products furnished and installed by Owner OFOI
 - 1. None.
- F. Items furnished by Owner for installation by Contractor
 - 1. Toilet Tissue Dispensers
 - 2. Soap Dispensers
 - 3. Paper Towel Dispensers
 - 4. Television Monitors
 - 5. Metal Lockers (Quantity: 100 provided by owner)
 - 6. Musical Instrument Storage Cabinets. Partial, see drawings for quantity and type

provided by owner.

1.5 CONTRACTOR USE OF SITE AND PREMISES

- A. Limit use of site and premises to allow:
 - 1. Owner occupancy.
 - 2. Use of site and premises by public.
 - 3. Work by others and Work by Owner.
- B. Construction Operations: Limited to area indicated on drawings.

1.6 OWNER OCCUPANCY

- A. Full Owner Occupancy: Owner will occupy entire site and premises for the entire construction period for conduct of their normal operation.
- B. Owner Occupancy of Completed Areas of Construction: Owner reserves the right to occupy and to place and install equipment in completed areas of building, before Substantial Completion, provided such occupancy does not interfere with completion of the Work. Such placement of equipment and partial occupancy shall not constitute acceptance of the total Work.
- C. Architect will prepare a Certificate of Substantial Completion for each specific portion of the Work to be occupied before Owner occupancy.
- D. Before partial Owner occupancy, mechanical and electrical systems shall be fully operational, and required tests and inspections shall be successfully completed. On occupancy, Owner will operate and maintain mechanical and electrical systems serving occupied portions of building.
- E. On occupancy, Owner will assume responsibility for maintenance and custodial service for occupied portions of building.
- F. Cooperate with Owner during construction operations to minimize conflicts and facilitate Owner usage.
- G. Perform the Work so as not to interfere with Owner's day-to-day operations.
- H. Maintain existing exits, unless otherwise indicated.
- I. Provide not less than 72 hours notice to Owner of activities that will affect Owner's operations.

1.7 WORK RESTRICTIONS

- A. On-Site Work Hours: Work shall be generally performed during normal business working hours, Monday through Friday, except as otherwise indicated or required to conform to construction schedule and labor codes.

1. Weekend Hours: Per local ordinance.
 2. Early Morning Hours: Per local ordinance.
 3. Hours for Utility Shutdowns: Not during school hours. Notify owner 72 hours in advance.
 4. Hours for Noisy Operations: Coordinate with owner 72 hours in advance.
- B. Existing Utility Interruptions: Do not interrupt utilities serving facilities occupied by Owner or others unless permitted to do so and then only after arranging to provide temporary utility services according to requirements indicated.
1. Notify Owner and Architect not less than 5 days in advance of proposed utility interruptions. Do not proceed with utility interruptions without Owner's permission.

END OF SECTION

THIS PAGE LEFT INTENTIONALLY BLANK




















IDENTIFICATION STAMP
 PROJECT NO. 2017-01
 DATE 01-17-2015
 AC 01-17-2015

REVISIONS	DESCRIPTION	DATE
1	REVISIONS	01-17-2015


DATE ISSUED: 01-17-2015
 PROJECT NO: 2017-01
 SCALE: AS SHOWN

SHEET NUMBER: GEN
 SHEET TITLE: GENERAL ACCESSIBILITY

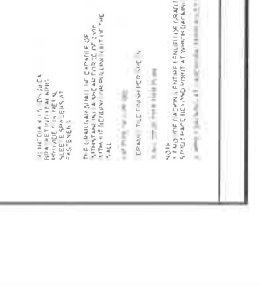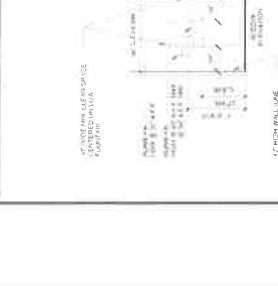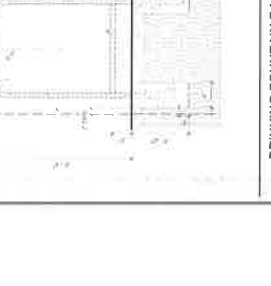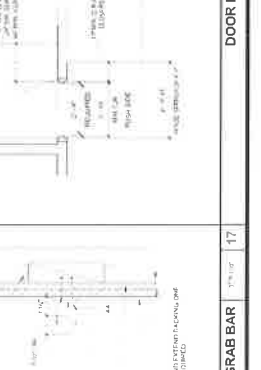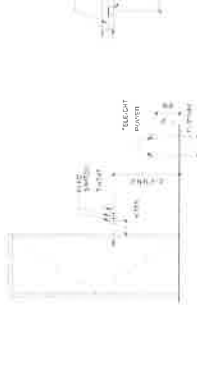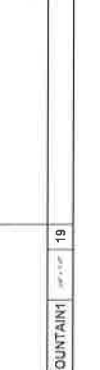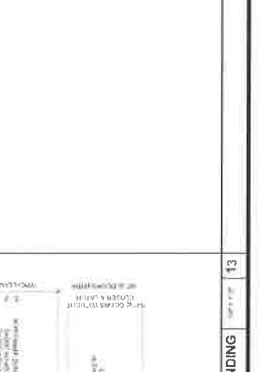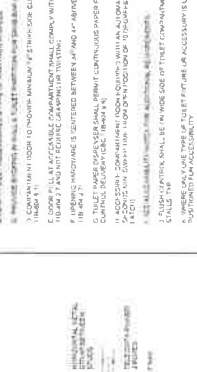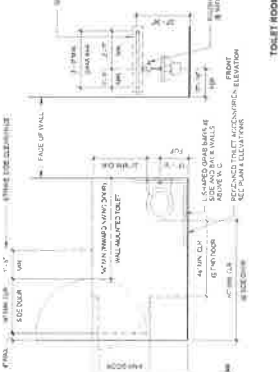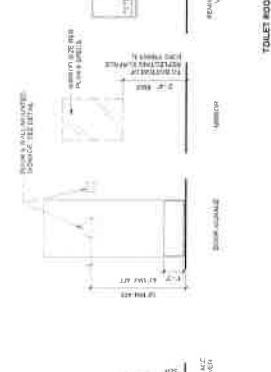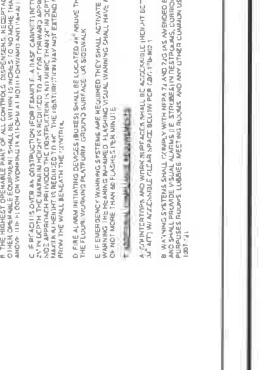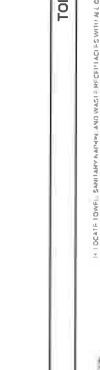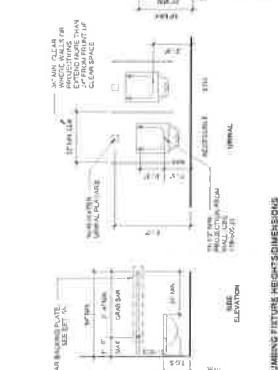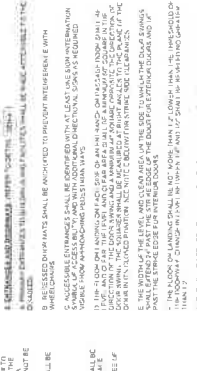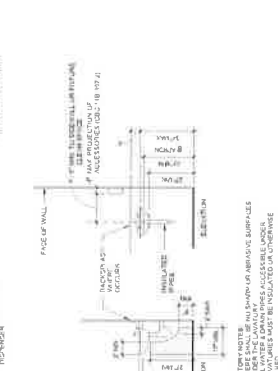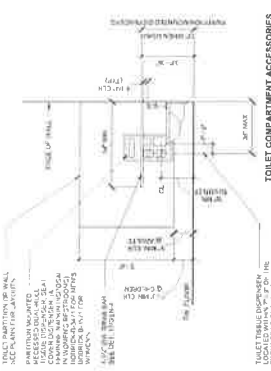

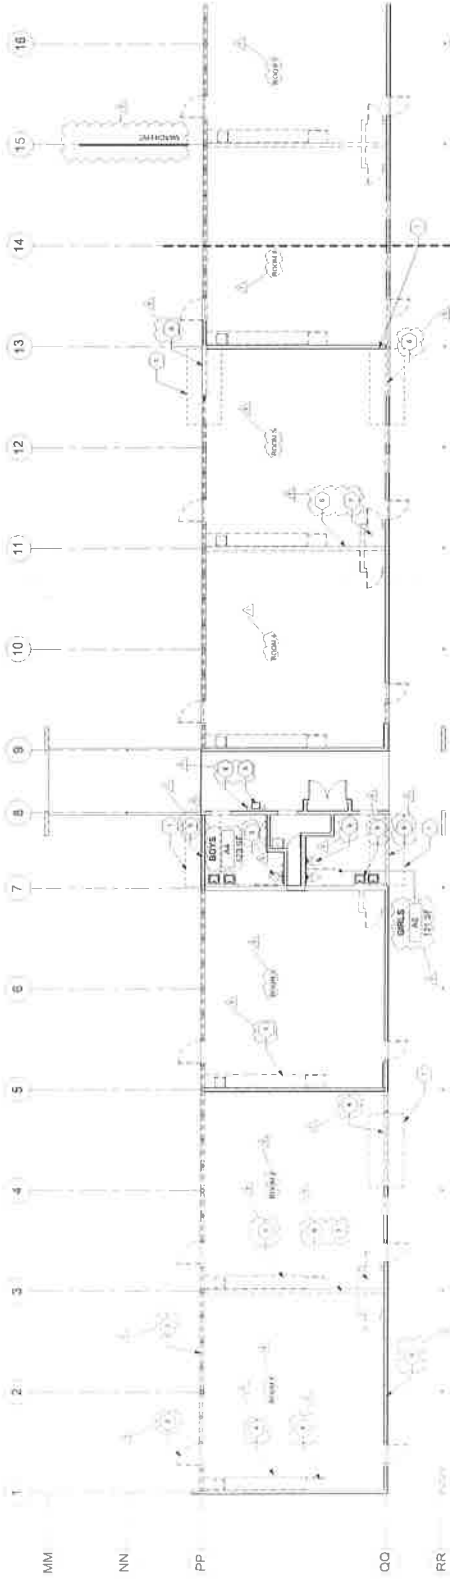

BUILDING A DEMOLITION FLOOR PLAN - AREA A	1
---	---

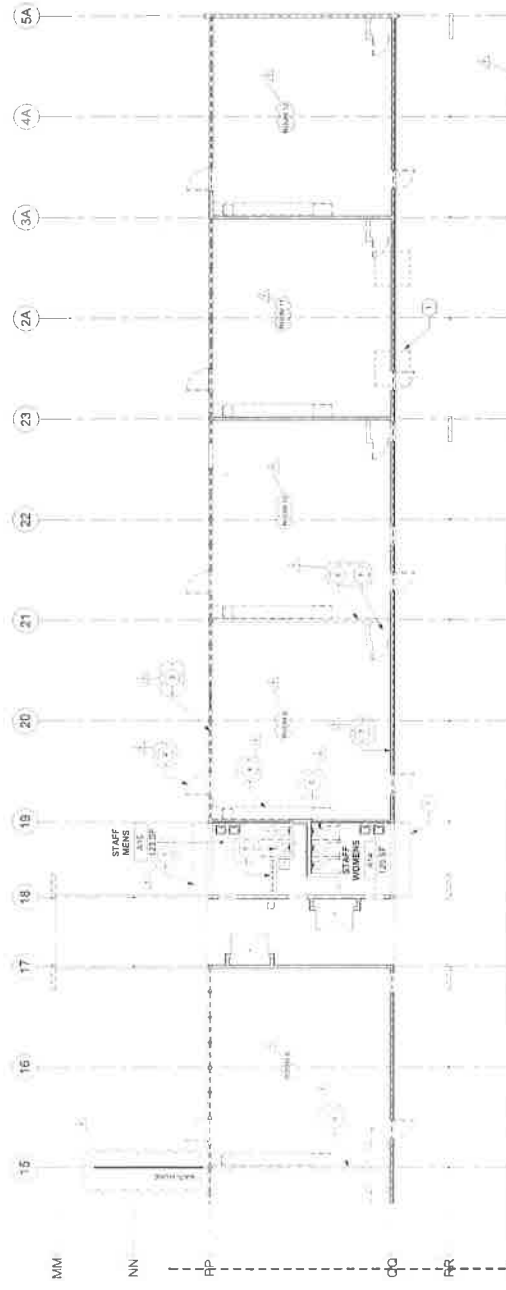

BUILDING A DEMOLITION CORPORATION - AREA B

BUILDING A DEMOLITION KEY NOTES

[illegible]

DEMOLITION NOTES

[illegible]

DEMO PLAN LEGEND



IDENTIFICATION STAMP
DATE: 10/2/2017
PROJECT NO: 04-01-17275
OFFICE OF REGULATION SERVICE


REVISIONS:	DESCRIPTION	DATE
1	ADDENDUM 5	2-4-1

DATE ISSUED: 10/2/2017
PROJECT NO: 04-01-17275
SCALE: AS SHOWN


SHEET NUMBER: AA12
SHEET TITLE: BUILDING A COMPOSITE PLAN




10000 Rick M. Johnson
Professional Engineer
State of California
No. 10000
Exp. 12/31/2017

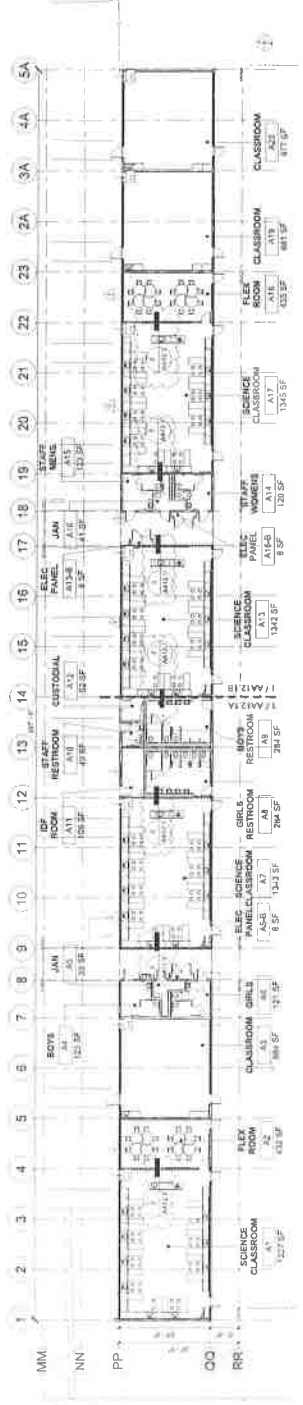

BUILDING A OVERALL IMPROVEMENT PLAN

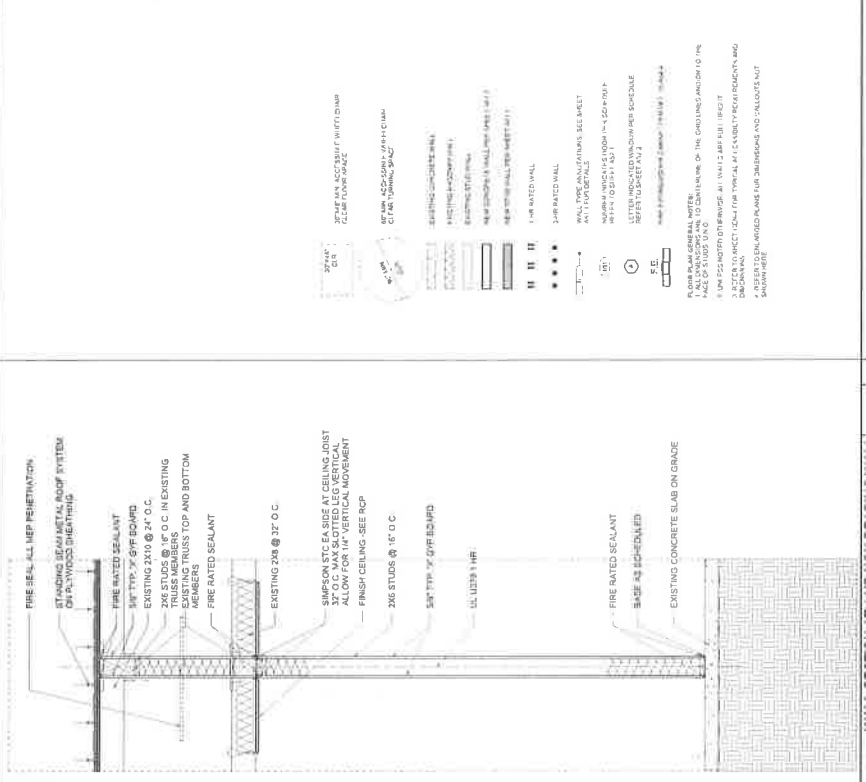

WALL SECTION AT 1 HR NON BEARING WALL

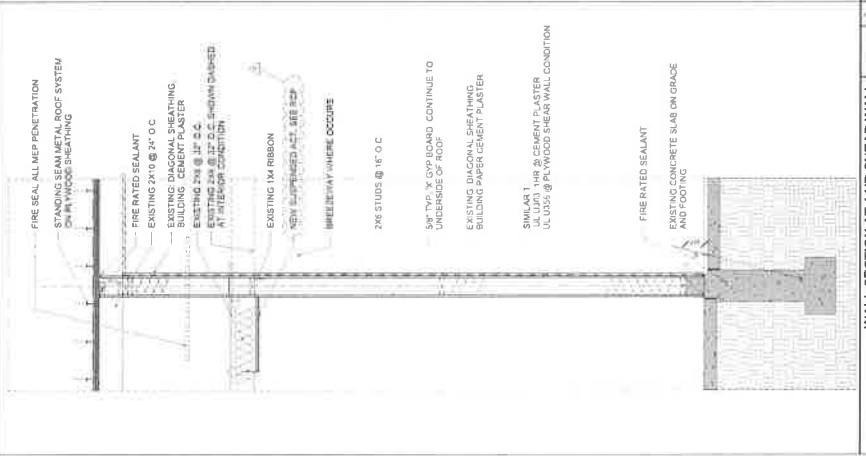

WALL SECTION AT 1 HR SHEAR WALL

FLOOR PLAN LEGEND	
1	2
3	4
5	6
7	8
9	10
11	12
13	14
15	16
17	18
19	20
21	22
23	24
25	26
27	28
29	30
31	32
33	34
35	36
37	38
39	40
41	42
43	44
45	46
47	48
49	50
51	52
53	54
55	56
57	58
59	60
61	62
63	64
65	66
67	68
69	70
71	72
73	74
75	76
77	78
79	80
81	82
83	84
85	86
87	88
89	90
91	92
93	94
95	96
97	98
99	100



DESCRIPTION	DATE
1. APPENDIX 5	2-4-1

SHEET NUMBER: AA12.1

SHEET TITLE:

**BUILDING A
IMPROVEMENT
PLAN AREA.**



BUILDING A IMPROVEMENT PLAN - AREA A

- 1 NEW SHEAR WALL AND FILLATION. SEE PLAN REFLECTION.
- 2 NEW 1/2" THICK CONCRETE FLOORING WITH 1" DEEP SET.
- 3 CONTINUOUS CONCRETE SHEAR WALL.
- 4 MECHANICAL EQUIPMENT. SEE MECHANICAL DRAWINGS.

BUILDING A IMPROVEMENT KEY NOTES

-

FLOOR PLAN GENERAL NOTES:

1. ALL DIMENSIONS ARE TO CENTERLINE OF THE CURB UNLESS NOTED OTHERWISE AND TO THE FACE OF STUDY CURB.
2. REFER TO SHEET 1000 FOR TYPICAL ACCESSIBILITY REQUIREMENTS AND DETAILS.
3. REFER TO ENLARGED PLANS FOR DIMENSIONS AND CALLOUTS NOT SHOWN HERE.

FLOOR PLAN LEGEND

OWNER: RAVENSWOOD CITY SCHOOL
DISTRICT
PROJECT NAME: RAVENSWOOD MS
REALIGNMENT PHASE 1
CLIENT ADDRESS: 2120 EUCLID AVENUE EAST PALO ALTO, CA 94303




IDENTIFICATION STAMP
OFFICE OF REGULATION SERVING
AA# 01-117275
AC PL SS

REVISION	DESCRIPTION	DATE
1	ADDENDUM 3	2-2-1

DATE ISSUED: 10/30/17
PROJECT NO: 2017-41
SCALE: AS SHOWN

SHEET NUMBER: AA12.1
SHEET TITLE:

BUILDING A
IMPROVEMENT
PLAN AREA B

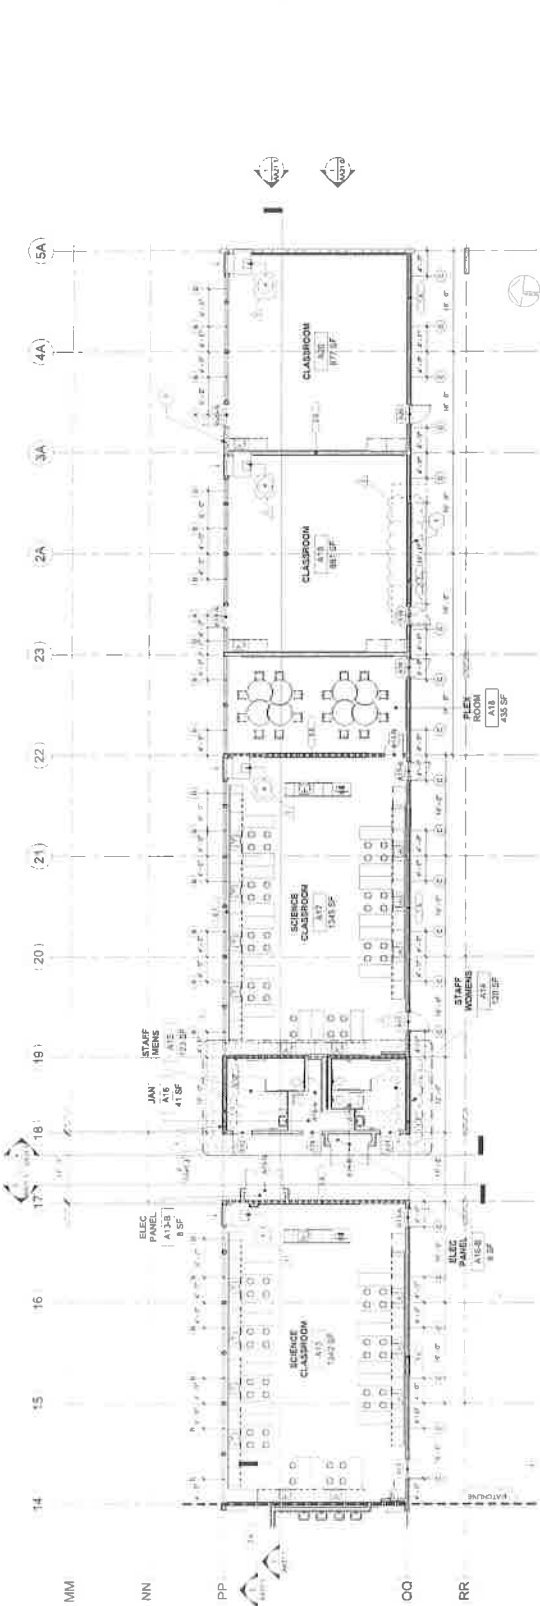

BUILDING A IMPROVEMENT PLAN - AREA B 1 of 1

- 1. NEW 1/2\"/>

BUILDING A IMPROVEMENT KEY NOTES

- 1. NEW 1/2\"/>

FLOOR PLAN LEGEND

OWNER: RAVENSWOOD CITY SCHOOL
 DISTRICT
 PROJECT NAME: RAVENSWOOD MS
 REALIGNMENT PHASE 1

CLIENT ADDRESS: 2120 EUCLID AVENUE EAST PALO ALTO, CA 94303



CERTIFICATION STAMP
 ROBERT M. JOHNSON, ARCHITECT
 OFFICE OF RAVENSWOOD, SEVEN
 AA 01-117275
 AC SLS SS
 DATE

REVISIONS	DESCRIPTION	DATE
1	ADDITIONALS	2/24/11


DATE ISSUED: 10/20/11
 PROJECT NO.: 1017-11
 SCALE: AS SHOWN

SHEET NUMBER: AA12
 SHEET TITLE:

BUILDING A
 BUILDING F
 ROOF PLANS




NOTES:
 1. ALL ROOF DECKS SHALL BE 4" THICK CONCRETE ON 2" X 8" JOISTS.
 2. ALL ROOF DECKS SHALL BE FINISHED WITH 2" OF 1/2" THICK GYPSUM BOARD.
 3. ALL ROOF DECKS SHALL BE FINISHED WITH 1/2" THICK GYPSUM BOARD.
 4. ALL ROOF DECKS SHALL BE FINISHED WITH 1/2" THICK GYPSUM BOARD.
 5. ALL ROOF DECKS SHALL BE FINISHED WITH 1/2" THICK GYPSUM BOARD.

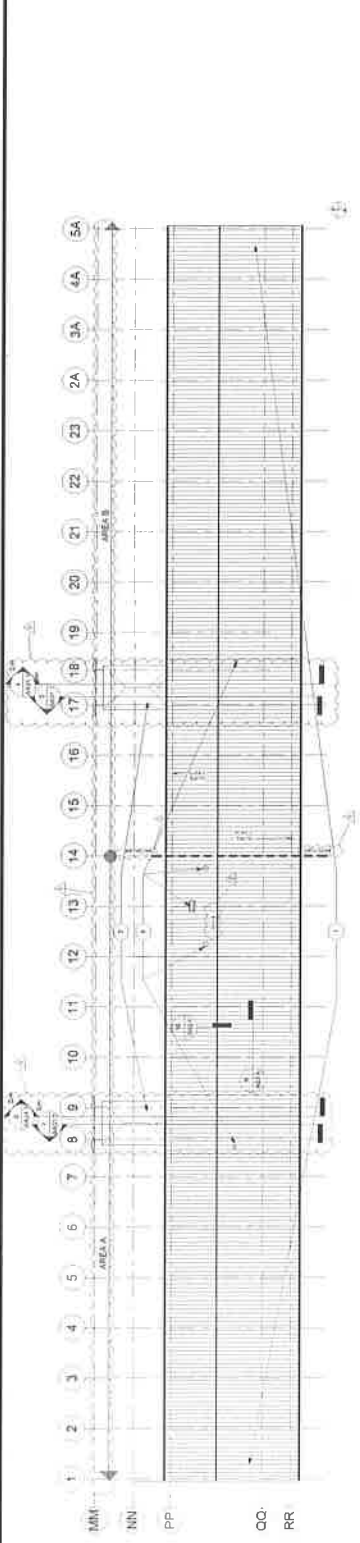

BUILDING A ROOF PLAN

BUILDING F ROOF PLAN

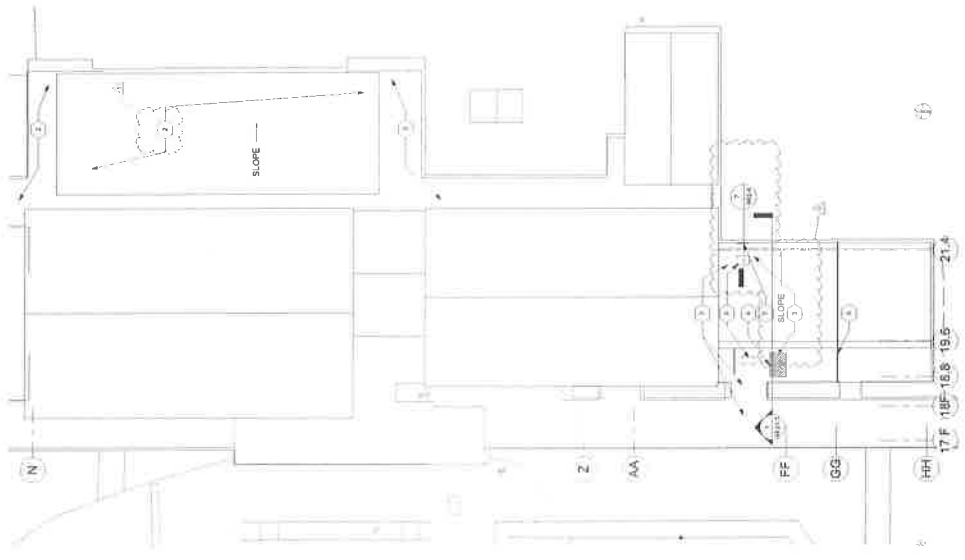

ROOF PLANS KEY NOTES

1. NEW AT RISING SEAM WITH ROOF AT BUILDING A
2. EXISTING ROOF FINISH
3. EXISTING ROOF FINISH
4. EXISTING ROOF FINISH
5. EXISTING ROOF FINISH
6. EXISTING ROOF FINISH
7. EXISTING ROOF FINISH
8. EXISTING ROOF FINISH
9. EXISTING ROOF FINISH
10. EXISTING ROOF FINISH
11. EXISTING ROOF FINISH
12. EXISTING ROOF FINISH
13. EXISTING ROOF FINISH
14. EXISTING ROOF FINISH
15. EXISTING ROOF FINISH
16. EXISTING ROOF FINISH
17. EXISTING ROOF FINISH
18. EXISTING ROOF FINISH
19. EXISTING ROOF FINISH
20. EXISTING ROOF FINISH
21. EXISTING ROOF FINISH
22. EXISTING ROOF FINISH
23. EXISTING ROOF FINISH
24. EXISTING ROOF FINISH

OWNER: RAVENSWOOD CITY SCHOOL DISTRICT
PROJECT NAME: RAVENSWOOD MS REALIGNMENT PHASE 1
CLIENT ADDRESS: 2120 EUCLID AVENUE EAST PALO ALTO, CA 94303

Robert M. Jensen

IDENTIFICATION STAMP
DIVISION OF THE STATE ARCHIVES
OFFICE OF THE COLLECTION SERVICES
A# 01-117275
4C 123 52

REVISIONS	DESCRIPTION	DATE
1	ADDITIONAL	2-1

DATE ISSUED:	10/30/2017
PROJECT NO:	2017-4
SCALE:	As indicated


SHEET NUMBER: AA14

**BUILDING A
RCP
COMPOSITE
DEMOLITION
PLAN**



SVA
ARCHITECT

© 1997 by Blackwell Science Ltd, *Journal of Internal Medicine* 241: 369–375

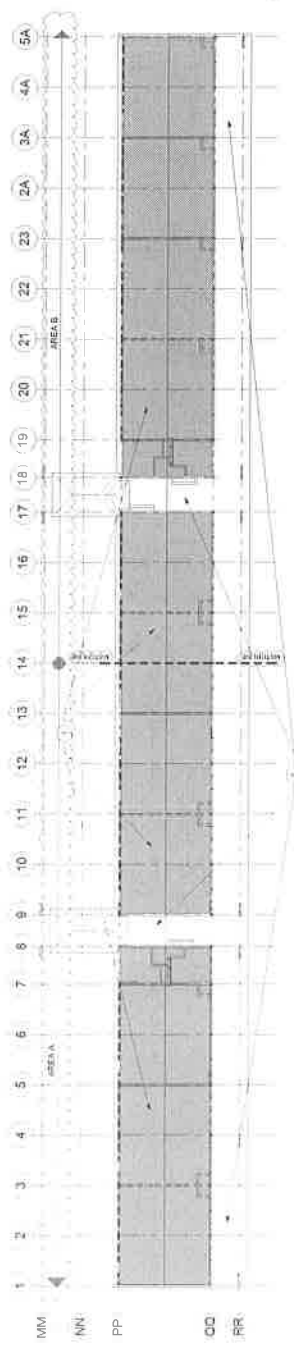

BUILDING A REFLECTED CEILING PLAN DEMOLITION	1	BUILDING A COMPOSITE DEMOLITION KEY NOTES
--	---	---

1. DEMOLISH EXISTING CEILING AND ASSOCIATED MECHANICAL EQUIPMENT, ATTENNAIRES, ETC.
2. FIVE (5) EXTERIOR CEILING SCOFFS TO NEARBY PATCH AND REPAIR ALL AREAS OF THE CHIMNEY, WINDOWS, RAIL, CEILING AND WALL TREATMENTS.

OWNER: RAVENSWOOD CITY SCHOOL DISTRICT
PROJECT NAME: RAVENSWOOD MS REALIGNMENT PHASE 1
CLIENT ADDRESS: 2120 EUCLID AVENUE EAST PALO ALTO, CA 94303




IDENTIFICATION STAMP
DATE: 01-11-2025
AC: RS CS

REVISIONS:	DESCRIPTION	DATE
1	ADDED	2-4-11


DATE REVISION: 10/30/2024
PROJECT NO: 2017-41
SCALE: 1/8" = 1'-0"

SHEET NUMBER: AA14
SHEET TITLE: BUILDING A RCP COMPOSITE IMPROVEMENT PLAN

OWNER: RAVENSWOOD CITY SCHOOL DISTRICT
PROJECT NAME: RAVENSWOOD MS REALIGNMENT PHASE 1
CLIENT ADDRESS: 2120 EUCLID AVENUE EAST PALO ALTO, CA 94303

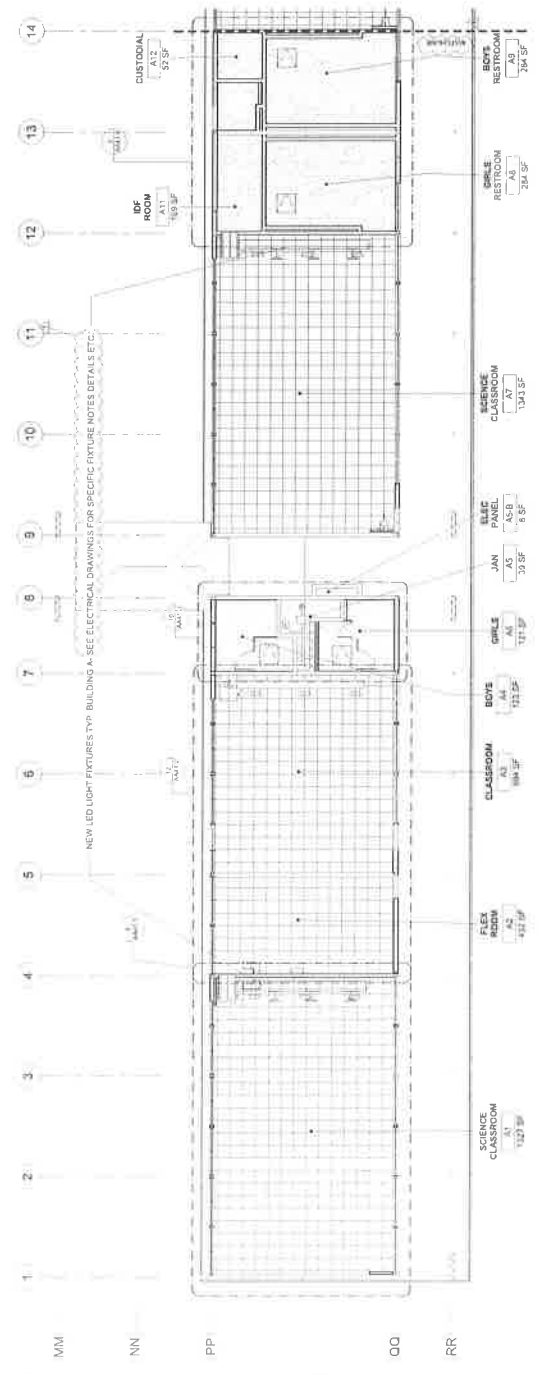

BUILDING A REFLECTED CEILING PLAN IMPROVEMENT AREA A

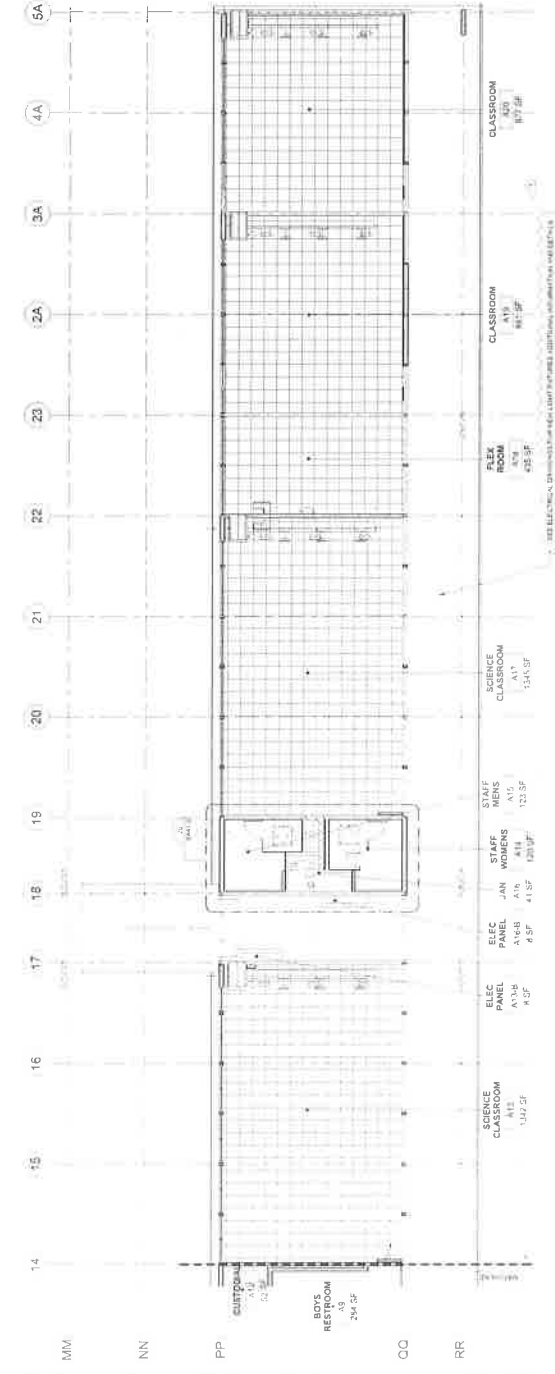

BUILDING A REFLECTED CEILING PLAN IMPROVEMENT AREA B

RCP LEGEND

OWNER: RAVENSWOOD CITY SCHOOL DISTRICT
PROJECT NAME: RAVENSWOOD MS REALIGNMENT PHASE 1
CLIENT ADDRESS: 2120 EUCLID AVENUE EAST PALO ALTO, CA 94303



IDENTIFICATION STAMP
DIVISION OF THE STATE ARCHITECT
ARCHITECT'S LICENSE NO. 10000
DATE: 01-17-2025

REVISIONS	DATE	BY	APP'D
1. APPROVED FOR CONSTRUCTION	01-17-2025	RA	RA


DATE SUBMITTED: 01-17-2025
PROJECT NO: 2021-01
SCALE: AS SHOWN

SHEET NUMBER: AA21
SHEET TITLE: BUILDING A ELEVATION DEMOLITION


DEMOLITION




EAST ELEVATION DEMOLITION 1/8" = 1'-0" 1

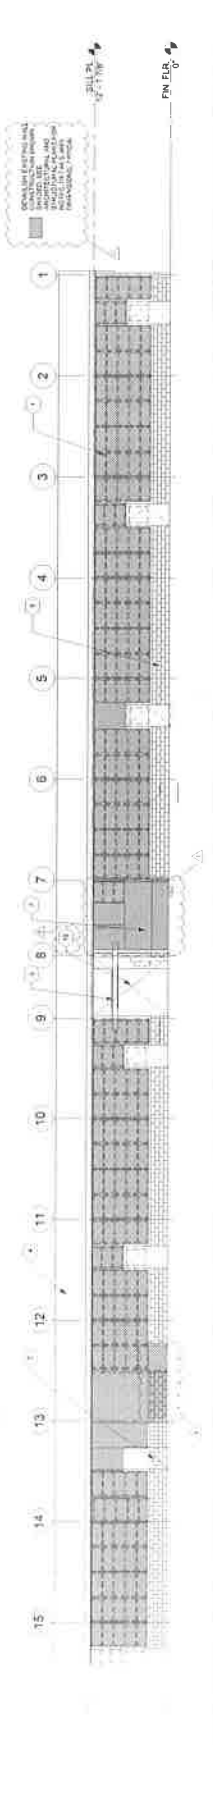


WEST ELEVATION DEMOLITION 1/8" = 1'-0" 2

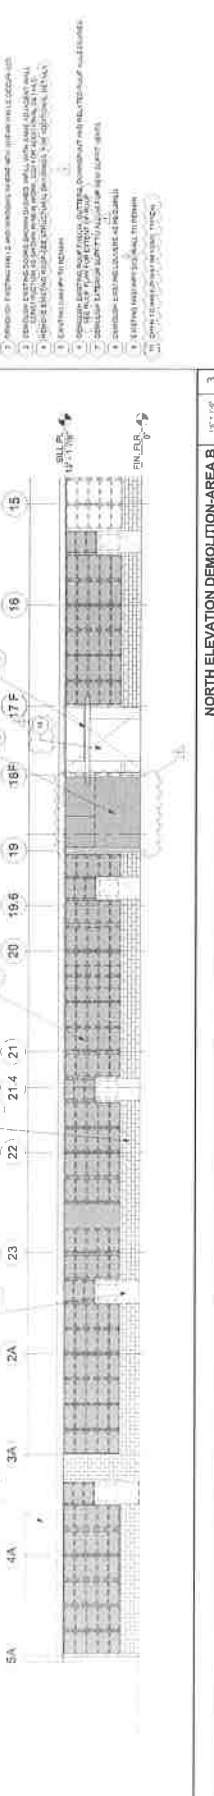

NORTH ELEVATION DEMOLITION-AREA A 1/8" = 1'-0" 3

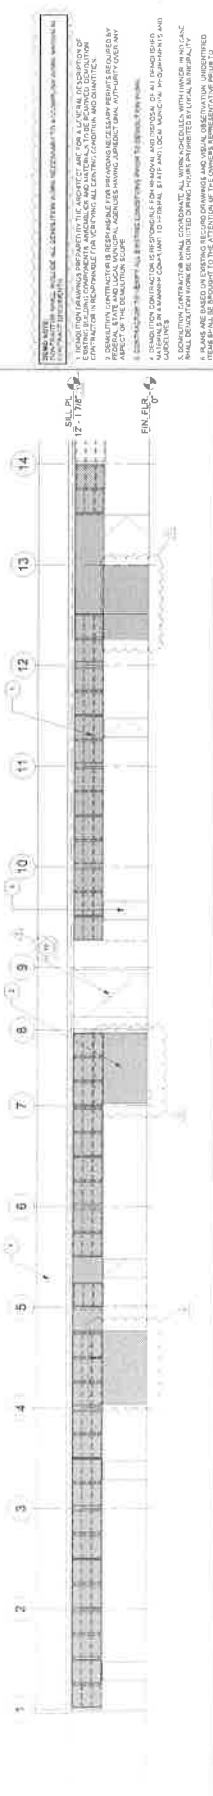



NORTH ELEVATION DEMOLITION-AREA B 1/8" = 1'-0" 4

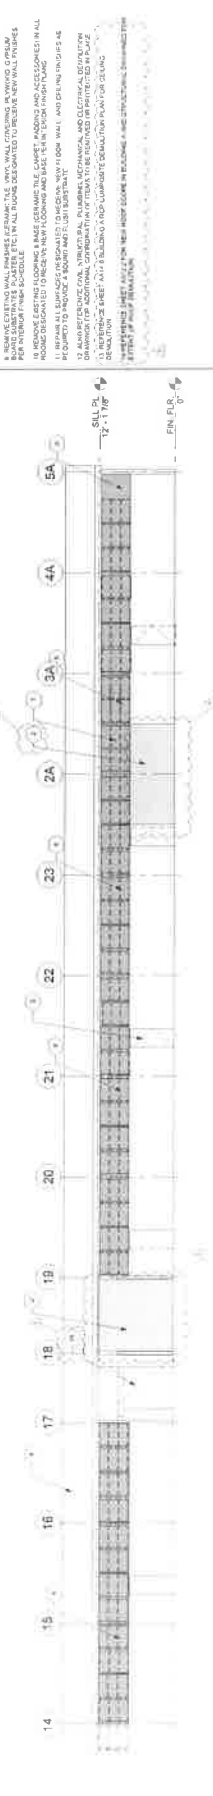

SOUTH ELEVATION DEMOLITION-AREA A 1/8" = 1'-0" 5

ELEVATION DEMOLITION KEY NOTES

1. DEMOLITION SHALL BE IN ACCORDANCE WITH THE CITY OF PALO ALTO'S DEMOLITION ORDINANCE (16.01.010) AND THE CALIFORNIA DEMOLITION ACT (925.00000).
2. DEMOLITION SHALL BE IN ACCORDANCE WITH THE CITY OF PALO ALTO'S DEMOLITION ORDINANCE (16.01.010) AND THE CALIFORNIA DEMOLITION ACT (925.00000).
3. DEMOLITION SHALL BE IN ACCORDANCE WITH THE CITY OF PALO ALTO'S DEMOLITION ORDINANCE (16.01.010) AND THE CALIFORNIA DEMOLITION ACT (925.00000).
4. DEMOLITION SHALL BE IN ACCORDANCE WITH THE CITY OF PALO ALTO'S DEMOLITION ORDINANCE (16.01.010) AND THE CALIFORNIA DEMOLITION ACT (925.00000).
5. DEMOLITION SHALL BE IN ACCORDANCE WITH THE CITY OF PALO ALTO'S DEMOLITION ORDINANCE (16.01.010) AND THE CALIFORNIA DEMOLITION ACT (925.00000).
6. DEMOLITION SHALL BE IN ACCORDANCE WITH THE CITY OF PALO ALTO'S DEMOLITION ORDINANCE (16.01.010) AND THE CALIFORNIA DEMOLITION ACT (925.00000).
7. DEMOLITION SHALL BE IN ACCORDANCE WITH THE CITY OF PALO ALTO'S DEMOLITION ORDINANCE (16.01.010) AND THE CALIFORNIA DEMOLITION ACT (925.00000).
8. DEMOLITION SHALL BE IN ACCORDANCE WITH THE CITY OF PALO ALTO'S DEMOLITION ORDINANCE (16.01.010) AND THE CALIFORNIA DEMOLITION ACT (925.00000).
9. DEMOLITION SHALL BE IN ACCORDANCE WITH THE CITY OF PALO ALTO'S DEMOLITION ORDINANCE (16.01.010) AND THE CALIFORNIA DEMOLITION ACT (925.00000).
10. DEMOLITION SHALL BE IN ACCORDANCE WITH THE CITY OF PALO ALTO'S DEMOLITION ORDINANCE (16.01.010) AND THE CALIFORNIA DEMOLITION ACT (925.00000).
11. DEMOLITION SHALL BE IN ACCORDANCE WITH THE CITY OF PALO ALTO'S DEMOLITION ORDINANCE (16.01.010) AND THE CALIFORNIA DEMOLITION ACT (925.00000).
12. DEMOLITION SHALL BE IN ACCORDANCE WITH THE CITY OF PALO ALTO'S DEMOLITION ORDINANCE (16.01.010) AND THE CALIFORNIA DEMOLITION ACT (925.00000).
13. DEMOLITION SHALL BE IN ACCORDANCE WITH THE CITY OF PALO ALTO'S DEMOLITION ORDINANCE (16.01.010) AND THE CALIFORNIA DEMOLITION ACT (925.00000).
14. DEMOLITION SHALL BE IN ACCORDANCE WITH THE CITY OF PALO ALTO'S DEMOLITION ORDINANCE (16.01.010) AND THE CALIFORNIA DEMOLITION ACT (925.00000).
15. DEMOLITION SHALL BE IN ACCORDANCE WITH THE CITY OF PALO ALTO'S DEMOLITION ORDINANCE (16.01.010) AND THE CALIFORNIA DEMOLITION ACT (925.00000).
16. DEMOLITION SHALL BE IN ACCORDANCE WITH THE CITY OF PALO ALTO'S DEMOLITION ORDINANCE (16.01.010) AND THE CALIFORNIA DEMOLITION ACT (925.00000).
17. DEMOLITION SHALL BE IN ACCORDANCE WITH THE CITY OF PALO ALTO'S DEMOLITION ORDINANCE (16.01.010) AND THE CALIFORNIA DEMOLITION ACT (925.00000).
18. DEMOLITION SHALL BE IN ACCORDANCE WITH THE CITY OF PALO ALTO'S DEMOLITION ORDINANCE (16.01.010) AND THE CALIFORNIA DEMOLITION ACT (925.00000).
19. DEMOLITION SHALL BE IN ACCORDANCE WITH THE CITY OF PALO ALTO'S DEMOLITION ORDINANCE (16.01.010) AND THE CALIFORNIA DEMOLITION ACT (925.00000).
20. DEMOLITION SHALL BE IN ACCORDANCE WITH THE CITY OF PALO ALTO'S DEMOLITION ORDINANCE (16.01.010) AND THE CALIFORNIA DEMOLITION ACT (925.00000).
21. DEMOLITION SHALL BE IN ACCORDANCE WITH THE CITY OF PALO ALTO'S DEMOLITION ORDINANCE (16.01.010) AND THE CALIFORNIA DEMOLITION ACT (925.00000).

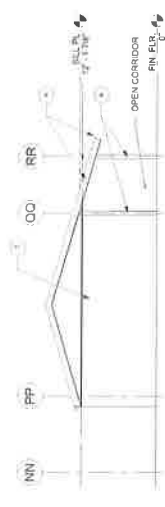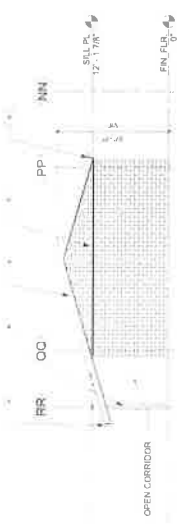

OWNER: RAVENSWOOD CITY SCHOOL DISTRICT
 PROJECT NAME: RAVENSWOOD MS REALIGNMENT PHASE 1
 CLIENT ADDRESS: 2120 EUCLID AVENUE EAST PALO ALTO, CA 94303



IDENTIFICATION: STATE ARCHITECT
 PROJECT NO. 2017-41
 SHEET NO. AA-21
 DATE: 01-11-2017

REVISION	DESCRIPTION	DATE
1	ADD NOTES AND PHASES	01-11-2017

DATE ISSUED: 01-11-2017
 PROJECT NO: 2017-41
 SCALE: AS SHOWN

SHEET NUMBER: AA-21
 SHEET TITLE: BUILDING A IMPROVEMENT ELEVATIONS


OWNER: RAVENSWOOD CITY SCHOOL DISTRICT
 PROJECT NAME: RAVENSWOOD MS REALIGNMENT PHASE 1
 CLIENT ADDRESS: 2120 EUCLID AVENUE EAST PALO ALTO, CA 94303




2120 EUCLID AVENUE EAST
 PALO ALTO, CA 94303
 TEL: 650.941.1234
 FAX: 650.941.1235
 WWW.SVA-ARCHITECT.COM

WEST EXTERIOR ELEVATION


EAST EXTERIOR ELEVATION

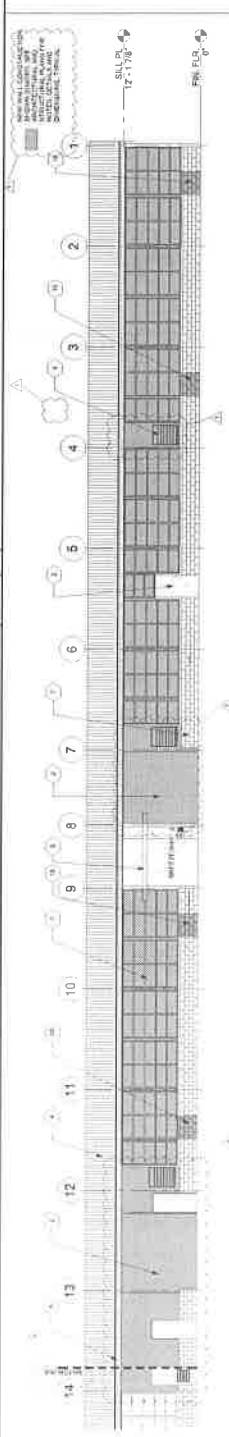


NORTH EXTERIOR ELEVATION- AREA A

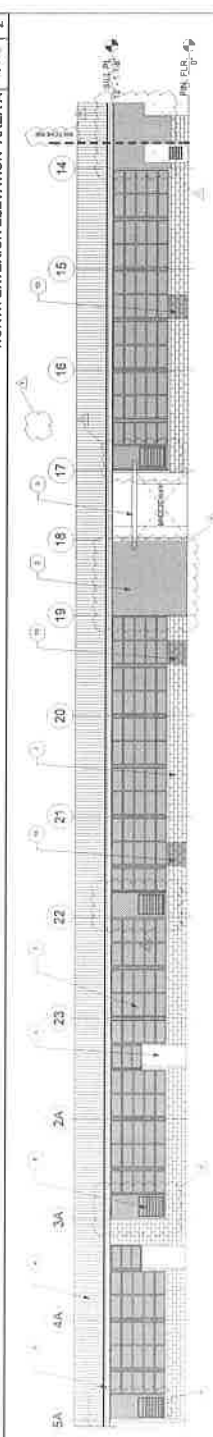

NORTH EXTERIOR ELEVATION- AREA B

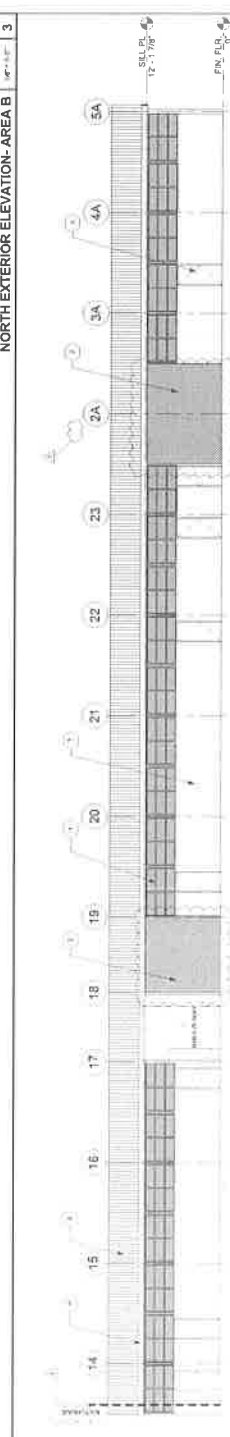

SOUTH EXTERIOR ELEVATION- AREA A

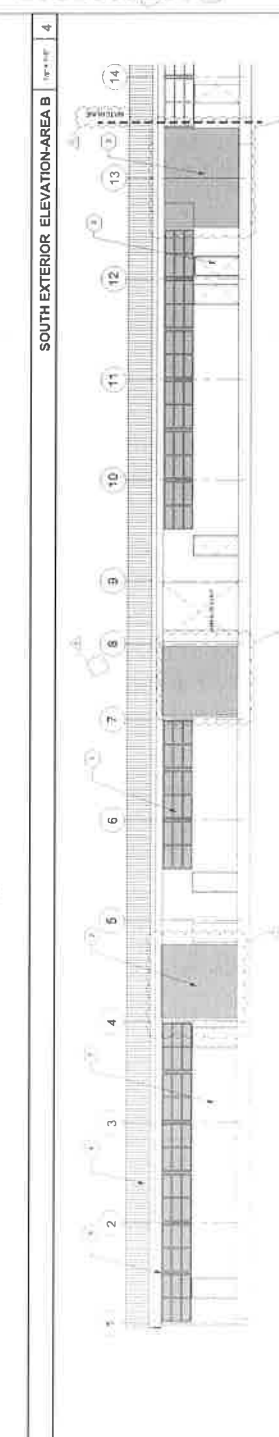

SOUTH EXTERIOR ELEVATION- AREA B

1. MATERIALS AND FINISHES: SEE SPECIFICATIONS AND NOTES.
2. GLAZING: SEE SPECIFICATIONS AND NOTES.
3. ROOFING: SEE SPECIFICATIONS AND NOTES.
4. EXTERIOR LIGHTING: SEE SPECIFICATIONS AND NOTES.
5. EXTERIOR FURNITURE: SEE SPECIFICATIONS AND NOTES.
6. EXTERIOR PLANTING: SEE SPECIFICATIONS AND NOTES.
7. EXTERIOR WALLS: SEE SPECIFICATIONS AND NOTES.
8. EXTERIOR DOORS: SEE SPECIFICATIONS AND NOTES.
9. EXTERIOR WINDOWS: SEE SPECIFICATIONS AND NOTES.
10. EXTERIOR STAIRS: SEE SPECIFICATIONS AND NOTES.
11. EXTERIOR RAMP: SEE SPECIFICATIONS AND NOTES.
12. EXTERIOR SIGNAGE: SEE SPECIFICATIONS AND NOTES.
13. EXTERIOR ACCESS: SEE SPECIFICATIONS AND NOTES.
14. EXTERIOR VENTILATION: SEE SPECIFICATIONS AND NOTES.
15. EXTERIOR SECURITY: SEE SPECIFICATIONS AND NOTES.
16. EXTERIOR MAINTENANCE: SEE SPECIFICATIONS AND NOTES.
17. EXTERIOR SAFETY: SEE SPECIFICATIONS AND NOTES.
18. EXTERIOR COMFORT: SEE SPECIFICATIONS AND NOTES.
19. EXTERIOR AESTHETICS: SEE SPECIFICATIONS AND NOTES.
20. EXTERIOR FUNCTIONALITY: SEE SPECIFICATIONS AND NOTES.
21. EXTERIOR DURABILITY: SEE SPECIFICATIONS AND NOTES.
22. EXTERIOR FLEXIBILITY: SEE SPECIFICATIONS AND NOTES.
23. EXTERIOR ADAPTABILITY: SEE SPECIFICATIONS AND NOTES.

ELEVATION IMPROVEMENT KEY NOTES

OWNER: RAVENSWOOD CITY SCHOOL DISTRICT
PROJECT NAME: RAVENSWOOD MS REALIGNMENT PHASE 1
CLIENT ADDRESS: 2120 EUCLID AVENUE EAST PALO ALTO, CA 94303

Robert M. Jensen

IDENTIFICATION STAMP
DIVISION OF THE STATE ARCHIVES
OFFICE OF REGULATION SERVICES
A# 01-117275
AC _____ FLS _____ SS _____

DATE _____

REVISIONS _____

1	ADDENDUM 5	24-1
---	------------	------

DATE _____


SCALE: As noted

SHEET NUMBER: AA31


SHEET TITLE:

BUILDING A
BUILDING
SECTIONS

BUILDING SECTION NORTH SOUTH 1	18" x 12"	1
--------------------------------	-----------	---

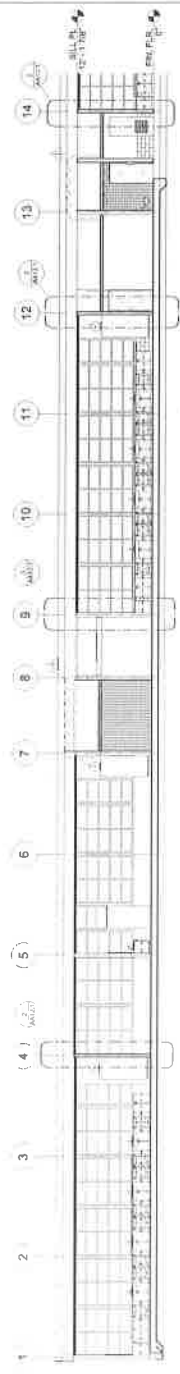


BUILDING SECTION AREA A EAST WEST 2	REV. 11-18	2
-------------------------------------	------------	---

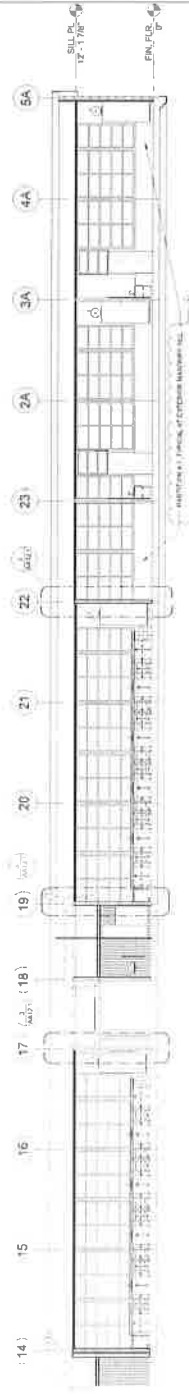

BUILDING SECTION AREA B EAST WEST J	10' x 12'	3
-------------------------------------	-----------	---



BUILDING SECTION NORTH SOUTH 4	4
--------------------------------	---

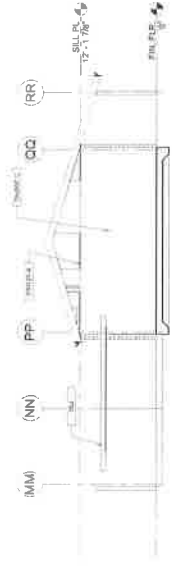

BUILDING SECTION NORTH SOUTH 6	18" x 10"	6
--------------------------------	-----------	---

[illegible]

SHEET NOTES

OWNER: RAVENSWOOD CITY SCHOOL DISTRICT
PROJECT NAME: RAVENSWOOD MS REALIGNMENT PHASE 1
CLIENT ADDRESS: 2120 EUCALYPT AVENUE EAST PALO ALTO, CA 94303


Robert M. Johnson

IDENTIFICATION STAMP
DIVISION OF THE STATE ARCHIVES
OFFICE OF REGULATION SERVICES
A# 01-117275
AC _____ FLS _____ SS _____

REVISIONS:	DESCRIPTION	DATE
1	ADDENDUMS	3-4-1

DATE ISSUED	10/20/14
PROJECT NO.	2017-11
SCALE	3/4" = 1'

SHEET NUMBER: AA32

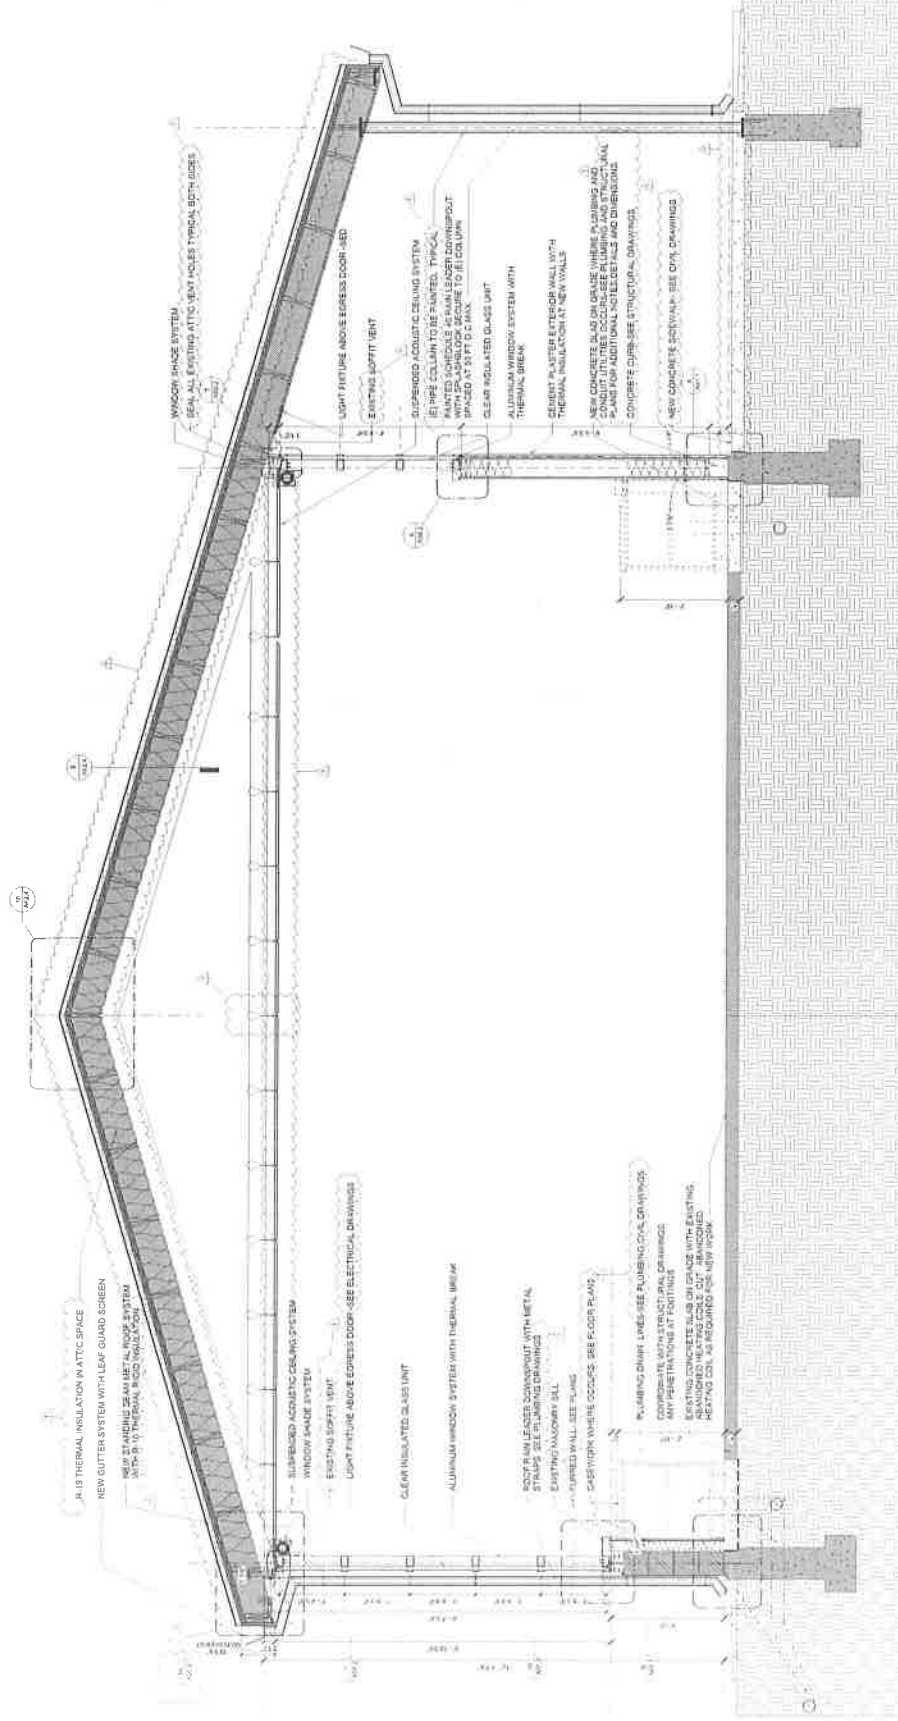BUILDING A
WALL
SECTIONS

OWNER: RAVENSWOOD CITY SCHOOL DISTRICT
 PROJECT NAME: RAVENSWOOD MS REALIGNMENT PHASE 1
 CLIENT ADDRESS: 2120 EUCLID AVENUE EAST PALO ALTO, CA 94303



IDENTIFICATION: RAMP
 DATE OF ISSUE: 01/17/25
 DATE OF PRELIMINARY: 01/17/25
 DATE OF FINAL: 01/17/25

REVISIONS	DESCRIPTION	DATE
1	ADDITIONAL	01/17/25


DATE ISSUED: 01/17/25
 PROJECT NO: 2017-01
 SCALE: 3/4" = 1'-0"

SHEET NUMBER: AA32
 SHEET TITLE:

BUILDING A
 WALL SECTION



11/17/25
 11/17/25
 11/17/25

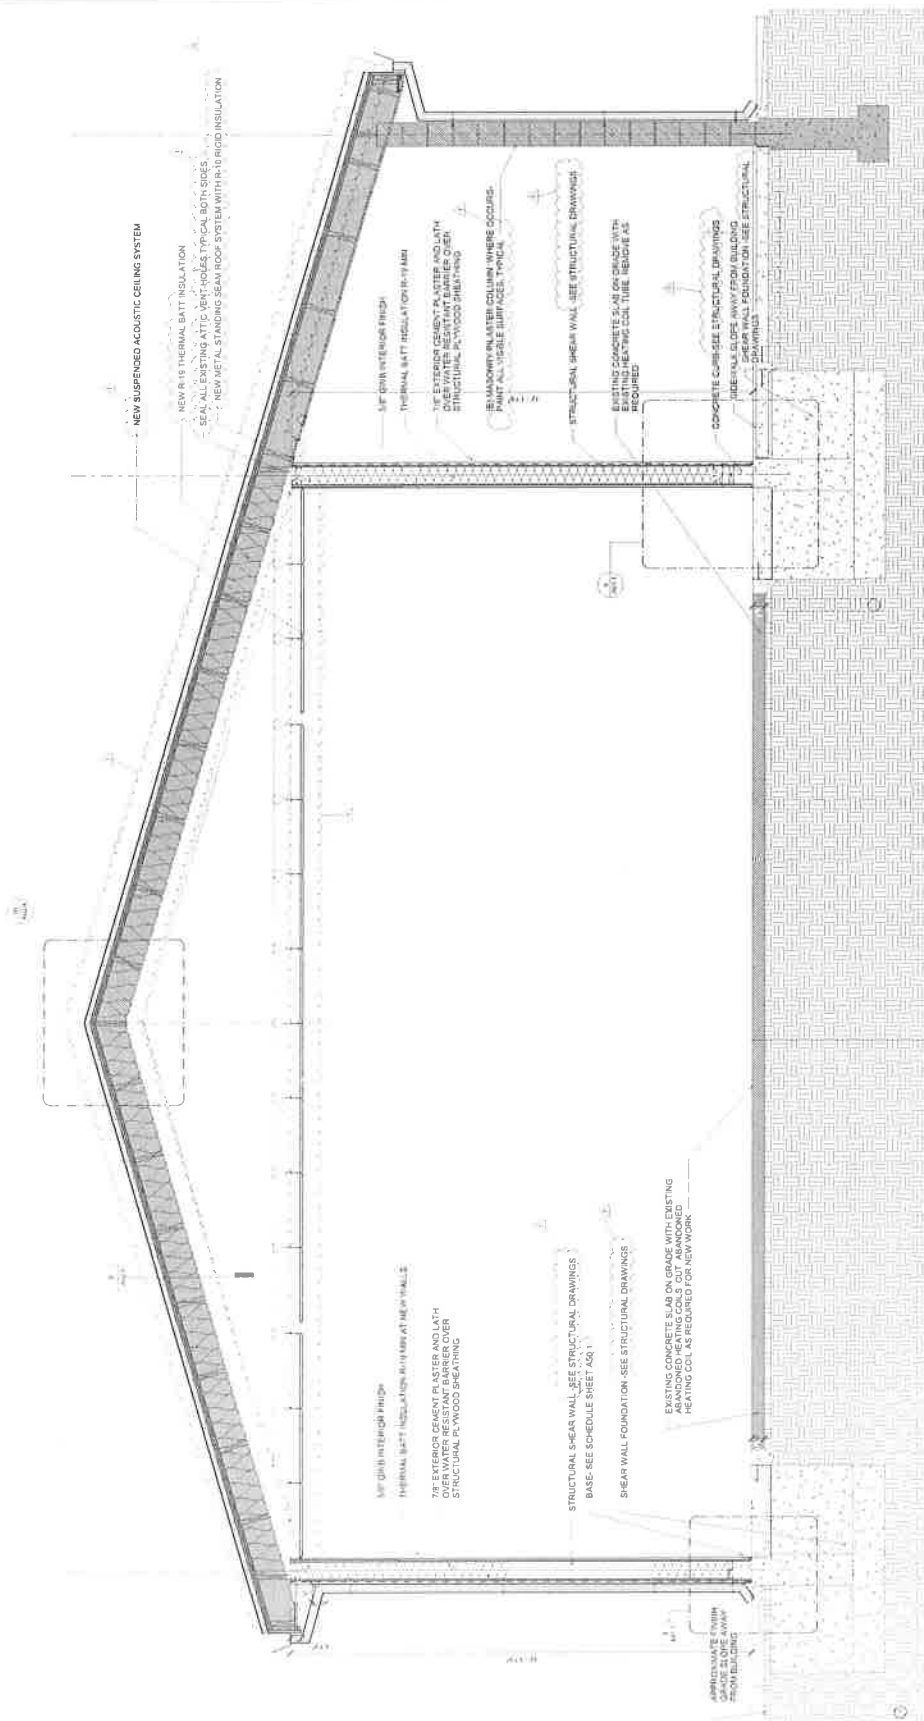

OWNER: RAVENSWOOD CITY SCHOOL
PROJECT NAME: RAVENSWOOD MS
DISTRICT
REALIGNMENT PHASE 1
CLIENT ADDRESS: 2120 EUCLID AVENUE EAST PALO ALTO, CA 94303



IDENTIFICATION STAMP
OFFICE OF REGULATION
DATE: 01-11-2025
PROJECT NO: 2017-41
SCALE: AS SHOWN

REVISIONS	DATE
1. ADDITION	2-4-1


DATE ISSUED: 10-20-21
PROJECT NO: 2017-41
SCALE: AS SHOWN

SHEET NUMBER: AA41
SHEET TITLE:


SCIENCE CLASSROOMS ENLARGED PLANS ELEVATIONS




1100 11th Street, Suite 100, San Francisco, CA 94103
415.774.8888
www.svaarchitect.com

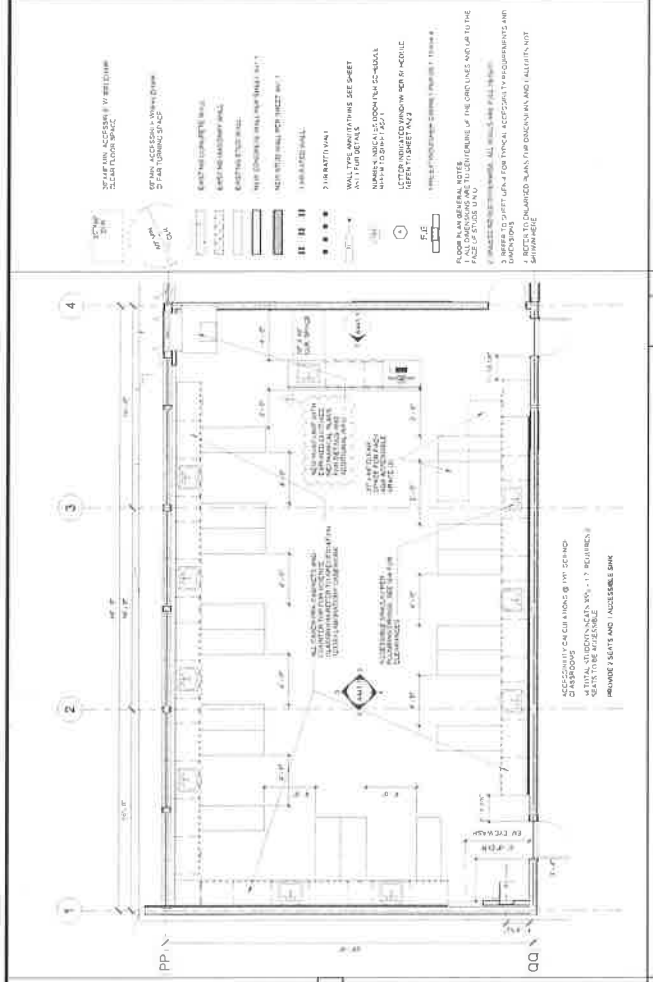

ENLARGED PLAN SCIENCE CLASSROOM

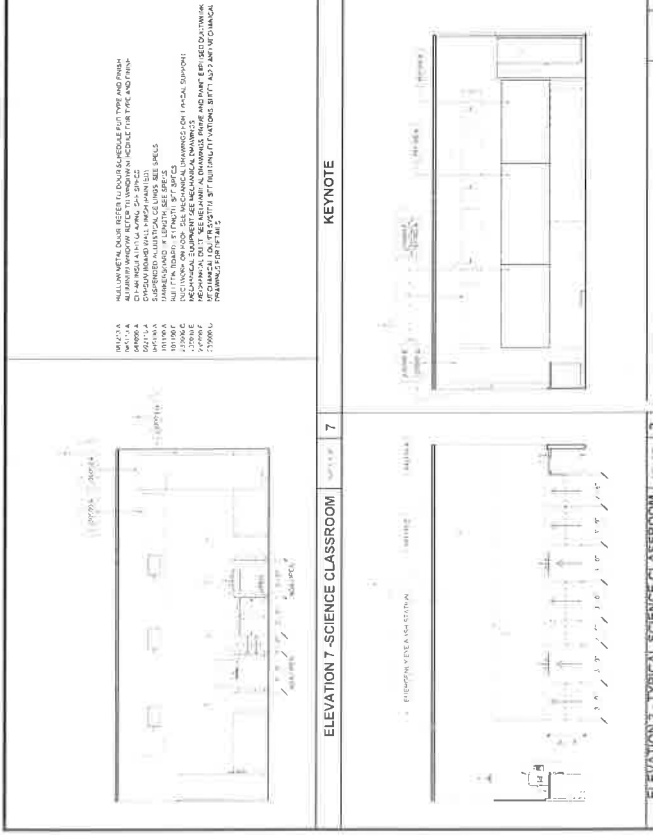


ELEVATION 3 - TYPICAL SCIENCE CLASSROOM

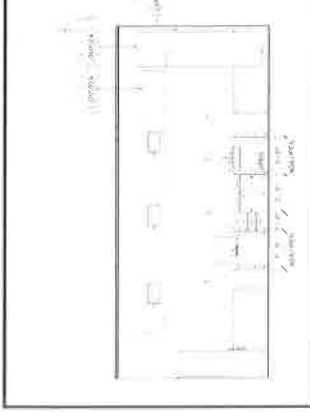


ELEVATION 7 - SCIENCE CLASSROOM


KEYNOTE

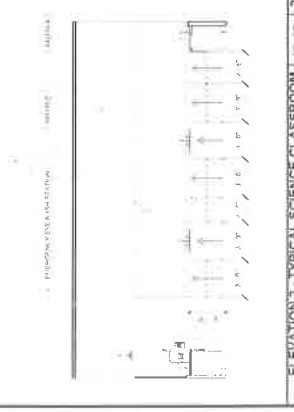


ELEVATION 2 - TYPICAL SCIENCE CLASSROOM

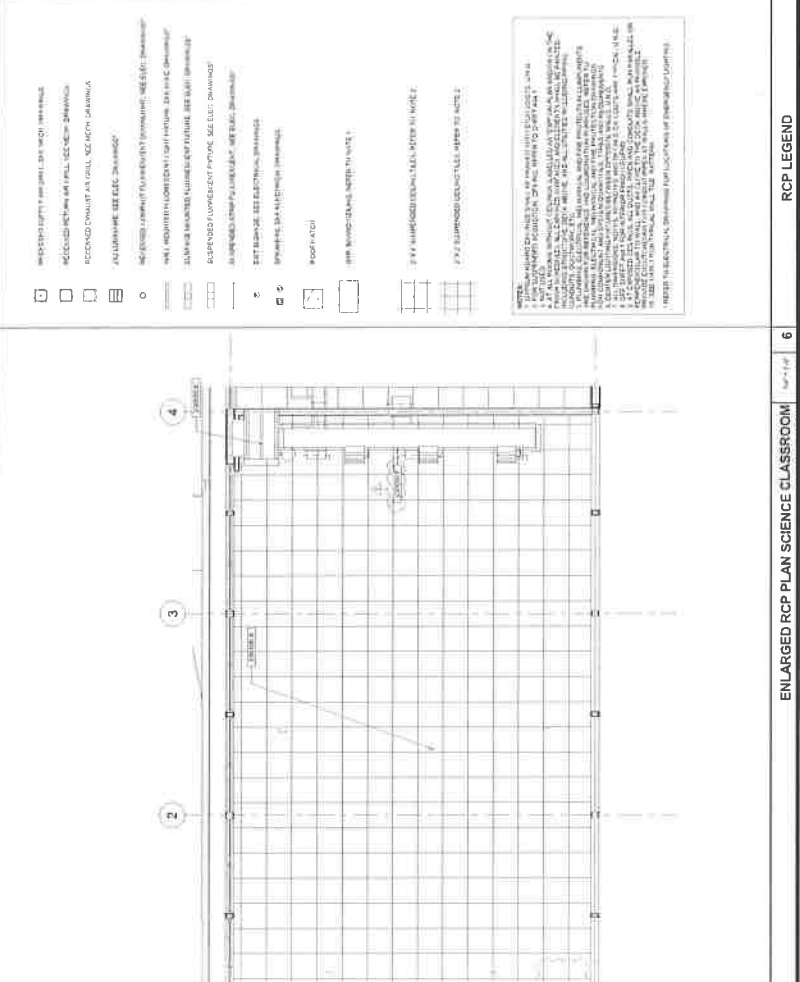

ENLARGED RCP PLAN SCIENCE CLASSROOM

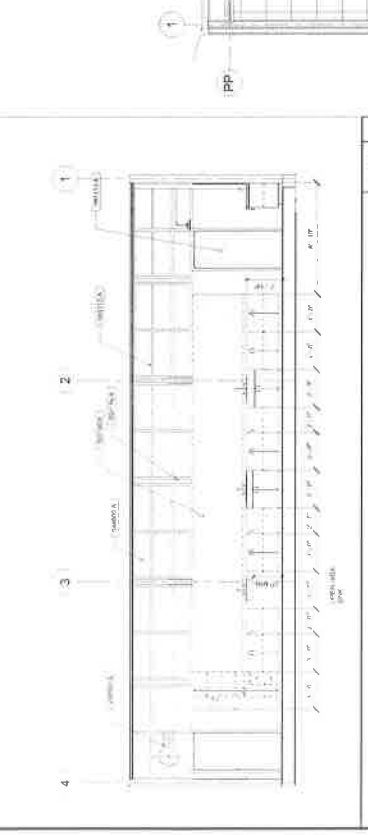

ELEVATION 4 - TYPICAL SCIENCE CLASSROOM

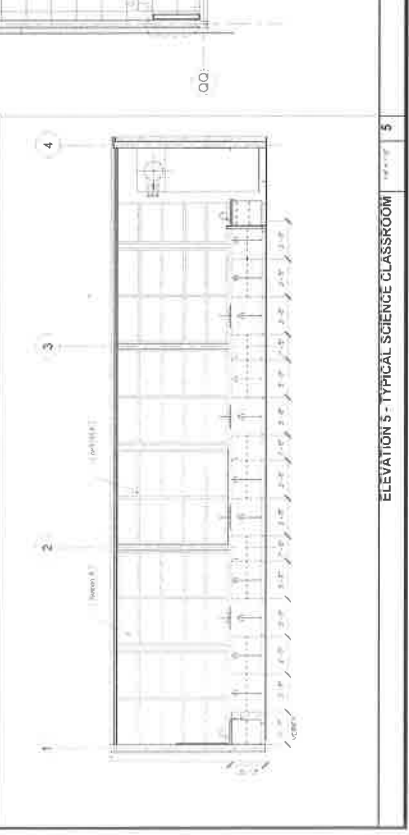

ELEVATION 5 - TYPICAL SCIENCE CLASSROOM

RCP LEGEND

OWNER: RAVENSWOOD CITY SCHOOL
 DISTRICT
 PROJECT NAME: RAVENSWOOD MS
 REALIGNMENT PHASE 1

CIENT ADDRESS: 2120 EUCLID AVENUE EAST PALO ALTO, CA 94303



IDENTIFICATION STAMP
 PROJECT NO. 2017-01
 DATE 01-11-2017
 SCALE AS SHOWN

REVISION	DESCRIPTION	DATE
1	ADDITIONAL	2-2-17

DATE ISSUED: 10-15-17
 PROJECT NO. 2017-01
 SCALE: AS SHOWN
 SHEET NUMBER: AA41
 SHEET TITLE: ENLARGED PLANS BOYS GIRLS STAFF TOILETS

ENLARGED PLANS BOYS GIRLS STAFF TOILETS




KEYNOTES

- 1. REVISIONS TO THIS SET SHALL BE SHOWN BY A CIRCLE WITH THE NUMBER OF THE REVISION AND THE DATE OF THE REVISION.
- 2. ALL DIMENSIONS ARE IN FEET AND INCHES. DIMENSIONS ARE SHOWN TO THE CENTER OF THE DIMENSIONED ELEMENT UNLESS OTHERWISE NOTED.
- 3. ALL DIMENSIONS ARE TO THE CENTER OF THE DIMENSIONED ELEMENT UNLESS OTHERWISE NOTED.
- 4. ALL DIMENSIONS ARE TO THE CENTER OF THE DIMENSIONED ELEMENT UNLESS OTHERWISE NOTED.
- 5. ALL DIMENSIONS ARE TO THE CENTER OF THE DIMENSIONED ELEMENT UNLESS OTHERWISE NOTED.
- 6. ALL DIMENSIONS ARE TO THE CENTER OF THE DIMENSIONED ELEMENT UNLESS OTHERWISE NOTED.
- 7. ALL DIMENSIONS ARE TO THE CENTER OF THE DIMENSIONED ELEMENT UNLESS OTHERWISE NOTED.
- 8. ALL DIMENSIONS ARE TO THE CENTER OF THE DIMENSIONED ELEMENT UNLESS OTHERWISE NOTED.
- 9. ALL DIMENSIONS ARE TO THE CENTER OF THE DIMENSIONED ELEMENT UNLESS OTHERWISE NOTED.
- 10. ALL DIMENSIONS ARE TO THE CENTER OF THE DIMENSIONED ELEMENT UNLESS OTHERWISE NOTED.
- 11. ALL DIMENSIONS ARE TO THE CENTER OF THE DIMENSIONED ELEMENT UNLESS OTHERWISE NOTED.
- 12. ALL DIMENSIONS ARE TO THE CENTER OF THE DIMENSIONED ELEMENT UNLESS OTHERWISE NOTED.
- 13. ALL DIMENSIONS ARE TO THE CENTER OF THE DIMENSIONED ELEMENT UNLESS OTHERWISE NOTED.
- 14. ALL DIMENSIONS ARE TO THE CENTER OF THE DIMENSIONED ELEMENT UNLESS OTHERWISE NOTED.
- 15. ALL DIMENSIONS ARE TO THE CENTER OF THE DIMENSIONED ELEMENT UNLESS OTHERWISE NOTED.
- 16. ALL DIMENSIONS ARE TO THE CENTER OF THE DIMENSIONED ELEMENT UNLESS OTHERWISE NOTED.
- 17. ALL DIMENSIONS ARE TO THE CENTER OF THE DIMENSIONED ELEMENT UNLESS OTHERWISE NOTED.
- 18. ALL DIMENSIONS ARE TO THE CENTER OF THE DIMENSIONED ELEMENT UNLESS OTHERWISE NOTED.
- 19. ALL DIMENSIONS ARE TO THE CENTER OF THE DIMENSIONED ELEMENT UNLESS OTHERWISE NOTED.
- 20. ALL DIMENSIONS ARE TO THE CENTER OF THE DIMENSIONED ELEMENT UNLESS OTHERWISE NOTED.

NOTES:
 1. ALL DIMENSIONS ARE TO THE CENTER OF THE DIMENSIONED ELEMENT UNLESS OTHERWISE NOTED.
 2. ALL DIMENSIONS ARE TO THE CENTER OF THE DIMENSIONED ELEMENT UNLESS OTHERWISE NOTED.
 3. ALL DIMENSIONS ARE TO THE CENTER OF THE DIMENSIONED ELEMENT UNLESS OTHERWISE NOTED.
 4. ALL DIMENSIONS ARE TO THE CENTER OF THE DIMENSIONED ELEMENT UNLESS OTHERWISE NOTED.
 5. ALL DIMENSIONS ARE TO THE CENTER OF THE DIMENSIONED ELEMENT UNLESS OTHERWISE NOTED.
 6. ALL DIMENSIONS ARE TO THE CENTER OF THE DIMENSIONED ELEMENT UNLESS OTHERWISE NOTED.
 7. ALL DIMENSIONS ARE TO THE CENTER OF THE DIMENSIONED ELEMENT UNLESS OTHERWISE NOTED.
 8. ALL DIMENSIONS ARE TO THE CENTER OF THE DIMENSIONED ELEMENT UNLESS OTHERWISE NOTED.
 9. ALL DIMENSIONS ARE TO THE CENTER OF THE DIMENSIONED ELEMENT UNLESS OTHERWISE NOTED.
 10. ALL DIMENSIONS ARE TO THE CENTER OF THE DIMENSIONED ELEMENT UNLESS OTHERWISE NOTED.
 11. ALL DIMENSIONS ARE TO THE CENTER OF THE DIMENSIONED ELEMENT UNLESS OTHERWISE NOTED.
 12. ALL DIMENSIONS ARE TO THE CENTER OF THE DIMENSIONED ELEMENT UNLESS OTHERWISE NOTED.
 13. ALL DIMENSIONS ARE TO THE CENTER OF THE DIMENSIONED ELEMENT UNLESS OTHERWISE NOTED.
 14. ALL DIMENSIONS ARE TO THE CENTER OF THE DIMENSIONED ELEMENT UNLESS OTHERWISE NOTED.
 15. ALL DIMENSIONS ARE TO THE CENTER OF THE DIMENSIONED ELEMENT UNLESS OTHERWISE NOTED.
 16. ALL DIMENSIONS ARE TO THE CENTER OF THE DIMENSIONED ELEMENT UNLESS OTHERWISE NOTED.
 17. ALL DIMENSIONS ARE TO THE CENTER OF THE DIMENSIONED ELEMENT UNLESS OTHERWISE NOTED.
 18. ALL DIMENSIONS ARE TO THE CENTER OF THE DIMENSIONED ELEMENT UNLESS OTHERWISE NOTED.
 19. ALL DIMENSIONS ARE TO THE CENTER OF THE DIMENSIONED ELEMENT UNLESS OTHERWISE NOTED.
 20. ALL DIMENSIONS ARE TO THE CENTER OF THE DIMENSIONED ELEMENT UNLESS OTHERWISE NOTED.

RCP LEGEND

- 1. RCP LEGEND
- 2. RCP LEGEND
- 3. RCP LEGEND
- 4. RCP LEGEND
- 5. RCP LEGEND
- 6. RCP LEGEND
- 7. RCP LEGEND
- 8. RCP LEGEND
- 9. RCP LEGEND
- 10. RCP LEGEND
- 11. RCP LEGEND
- 12. RCP LEGEND
- 13. RCP LEGEND
- 14. RCP LEGEND
- 15. RCP LEGEND
- 16. RCP LEGEND
- 17. RCP LEGEND
- 18. RCP LEGEND
- 19. RCP LEGEND
- 20. RCP LEGEND

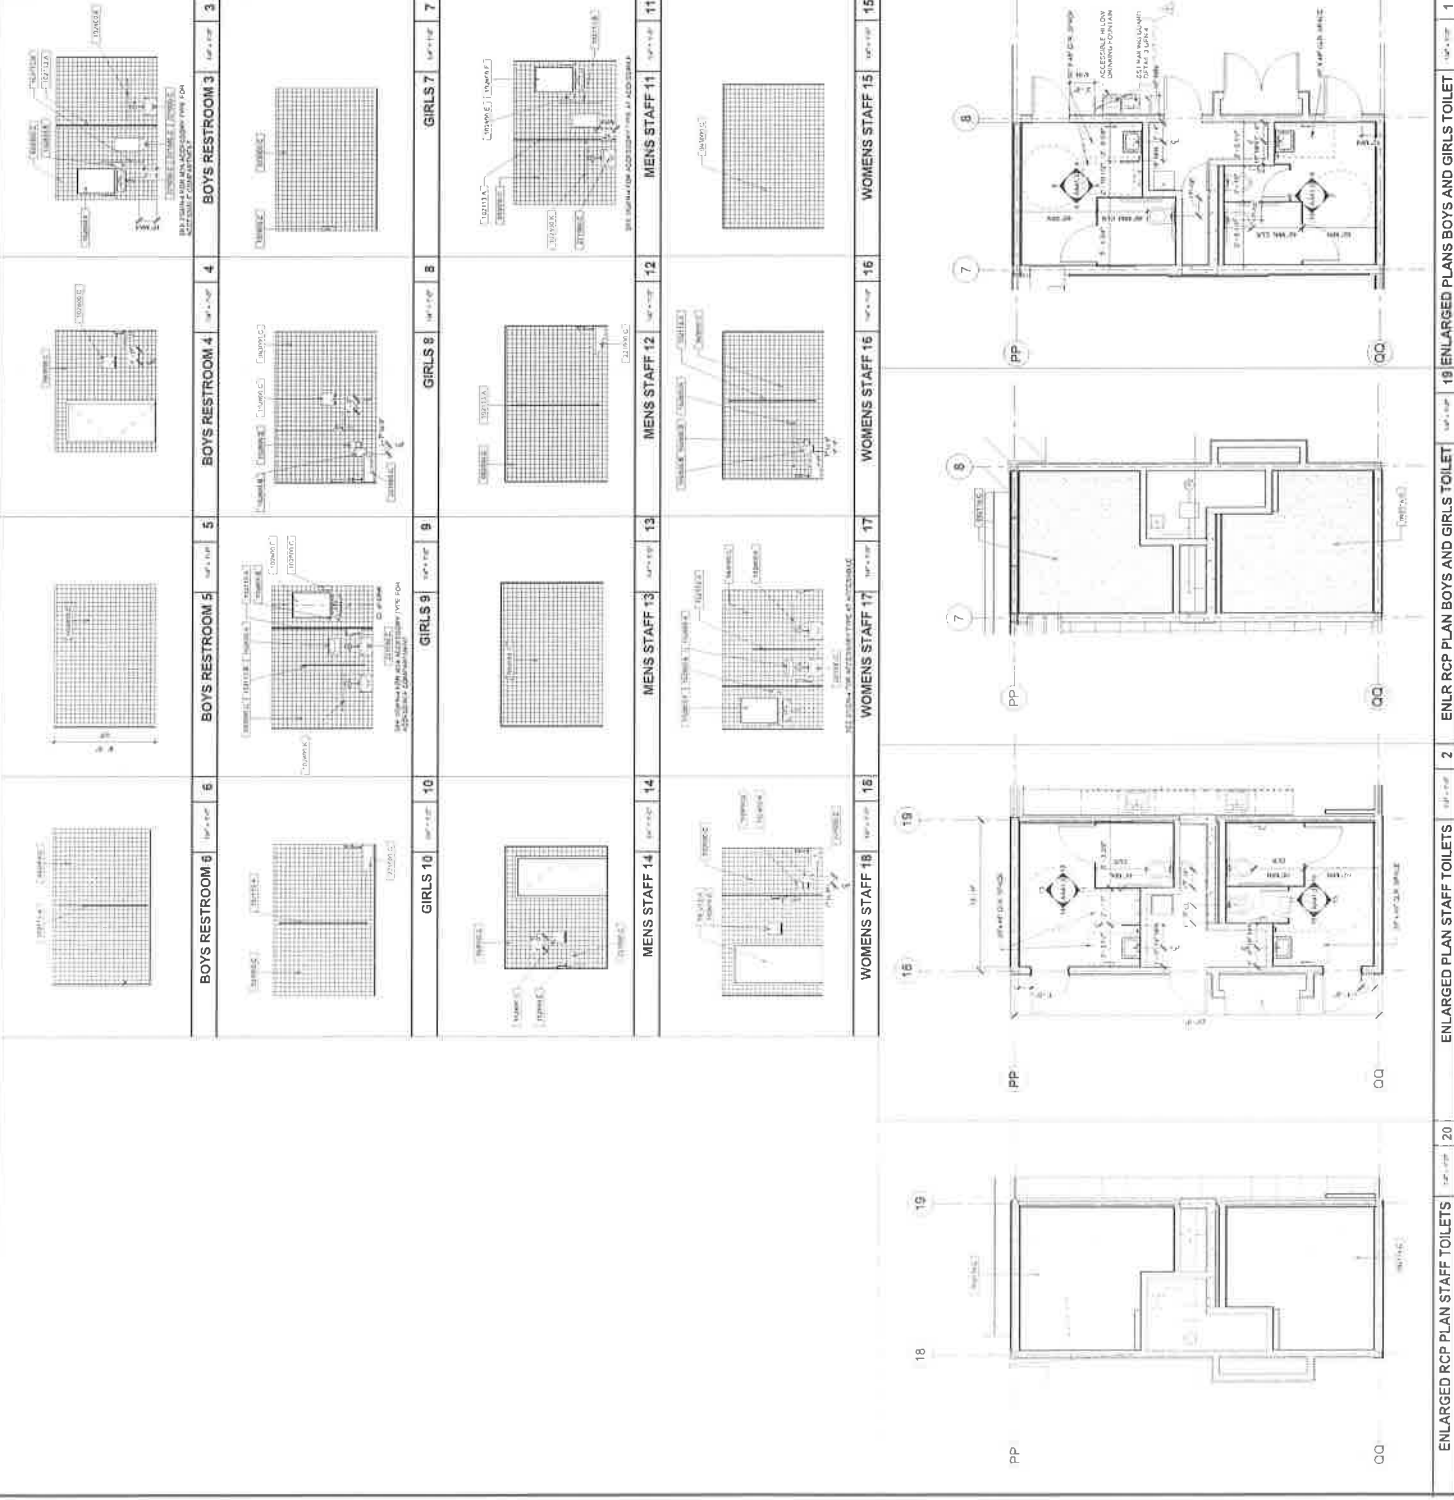

FLOOR PLAN LEGEND



DATE ISSUED	10/30/
PROJECT NO	2017-4
SCALE:	As indicated

ENLARGED
PLANS BOYS
AND GIRLS
RESTROOM



OWNER: RAVENSWOOD CITY SCHOOL DISTRICT
PROJECT NAME: RAVENSWOOD MS REALIGNMENT PHASE 1
CLIENT ADDRESS: 2120 EUCLID AVENUE EAST PALO ALTO, CA 94303




IDENTIFICATION: 17 PAGE
DATE OF REVISION: 06/10/2017
DATE OF REGISTRATION: 06/10/2017
A# 01-17275
AC: P5 SS
DATE:

REVISIONS	
DESCRIPTION	DATE
1. ADDENDUM 1	2-4-1

DATE ISSUED: 10/20/17
PROJECT NO: 2017-41
SCALE: AS SHOWN

SHEET NUMBER: AF12
SHEET TITLE: BUILDING F COMPOSITE IMPROVEMENT PLAN

OWNER: RAVENSWOOD CITY SCHOOL DISTRICT
PROJECT NAME: RAVENSWOOD MS REALIGNMENT PHASE 1
CLIENT ADDRESS: 2120 EUCLID AVENUE EAST PALO ALTO, CA 94303

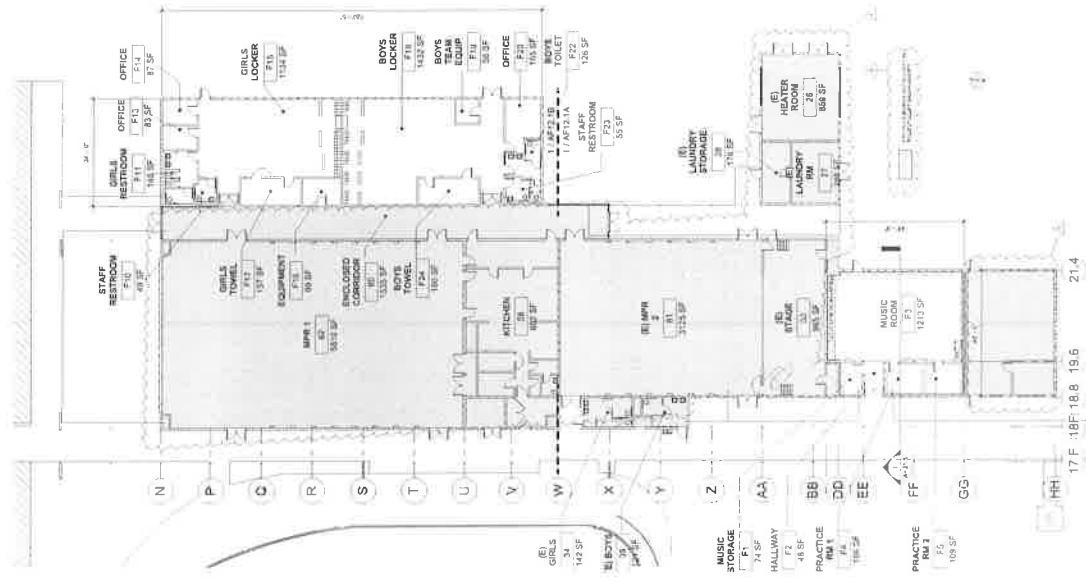

SHEET NOTES

- 1. ALL ROOMS ARE TO BE FINISHED WITH 1/2" GYPSUM BOARD ON 16" OC STUDS.
- 2. ALL WALLS ARE TO BE FINISHED WITH 1/2" GYPSUM BOARD ON 16" OC STUDS.
- 3. ALL FLOORS ARE TO BE FINISHED WITH 1/2" GYPSUM BOARD ON 16" OC JOISTS.
- 4. ALL CEILING ARE TO BE FINISHED WITH 1/2" GYPSUM BOARD ON 16" OC JOISTS.
- 5. ALL DOORS ARE TO BE FINISHED WITH 1/2" GYPSUM BOARD ON 16" OC STUDS.
- 6. ALL WINDOWS ARE TO BE FINISHED WITH 1/2" GYPSUM BOARD ON 16" OC STUDS.
- 7. ALL LIGHTS ARE TO BE FINISHED WITH 1/2" GYPSUM BOARD ON 16" OC STUDS.
- 8. ALL VENTS ARE TO BE FINISHED WITH 1/2" GYPSUM BOARD ON 16" OC STUDS.
- 9. ALL SINKS ARE TO BE FINISHED WITH 1/2" GYPSUM BOARD ON 16" OC STUDS.
- 10. ALL TUBS ARE TO BE FINISHED WITH 1/2" GYPSUM BOARD ON 16" OC STUDS.
- 11. ALL SHOWERS ARE TO BE FINISHED WITH 1/2" GYPSUM BOARD ON 16" OC STUDS.
- 12. ALL TOILETS ARE TO BE FINISHED WITH 1/2" GYPSUM BOARD ON 16" OC STUDS.
- 13. ALL LOCKERS ARE TO BE FINISHED WITH 1/2" GYPSUM BOARD ON 16" OC STUDS.
- 14. ALL OFFICES ARE TO BE FINISHED WITH 1/2" GYPSUM BOARD ON 16" OC STUDS.
- 15. ALL RESTROOMS ARE TO BE FINISHED WITH 1/2" GYPSUM BOARD ON 16" OC STUDS.
- 16. ALL KITCHENS ARE TO BE FINISHED WITH 1/2" GYPSUM BOARD ON 16" OC STUDS.
- 17. ALL MUSIC ROOMS ARE TO BE FINISHED WITH 1/2" GYPSUM BOARD ON 16" OC STUDS.
- 18. ALL PRACTICE ROOMS ARE TO BE FINISHED WITH 1/2" GYPSUM BOARD ON 16" OC STUDS.
- 19. ALL MUSIC STORAGE ARE TO BE FINISHED WITH 1/2" GYPSUM BOARD ON 16" OC STUDS.
- 20. ALL HEATERS ARE TO BE FINISHED WITH 1/2" GYPSUM BOARD ON 16" OC STUDS.
- 21. ALL LAUNDRIES ARE TO BE FINISHED WITH 1/2" GYPSUM BOARD ON 16" OC STUDS.
- 22. ALL EQUIPMENT ARE TO BE FINISHED WITH 1/2" GYPSUM BOARD ON 16" OC STUDS.
- 23. ALL TOWELS ARE TO BE FINISHED WITH 1/2" GYPSUM BOARD ON 16" OC STUDS.
- 24. ALL LOCKERS ARE TO BE FINISHED WITH 1/2" GYPSUM BOARD ON 16" OC STUDS.
- 25. ALL BOYS ARE TO BE FINISHED WITH 1/2" GYPSUM BOARD ON 16" OC STUDS.
- 26. ALL GIRLS ARE TO BE FINISHED WITH 1/2" GYPSUM BOARD ON 16" OC STUDS.
- 27. ALL STAFF ARE TO BE FINISHED WITH 1/2" GYPSUM BOARD ON 16" OC STUDS.
- 28. ALL RESTROOMS ARE TO BE FINISHED WITH 1/2" GYPSUM BOARD ON 16" OC STUDS.
- 29. ALL KITCHENS ARE TO BE FINISHED WITH 1/2" GYPSUM BOARD ON 16" OC STUDS.
- 30. ALL MUSIC ROOMS ARE TO BE FINISHED WITH 1/2" GYPSUM BOARD ON 16" OC STUDS.
- 31. ALL PRACTICE ROOMS ARE TO BE FINISHED WITH 1/2" GYPSUM BOARD ON 16" OC STUDS.
- 32. ALL MUSIC STORAGE ARE TO BE FINISHED WITH 1/2" GYPSUM BOARD ON 16" OC STUDS.
- 33. ALL HEATERS ARE TO BE FINISHED WITH 1/2" GYPSUM BOARD ON 16" OC STUDS.
- 34. ALL LAUNDRIES ARE TO BE FINISHED WITH 1/2" GYPSUM BOARD ON 16" OC STUDS.
- 35. ALL EQUIPMENT ARE TO BE FINISHED WITH 1/2" GYPSUM BOARD ON 16" OC STUDS.
- 36. ALL TOWELS ARE TO BE FINISHED WITH 1/2" GYPSUM BOARD ON 16" OC STUDS.
- 37. ALL LOCKERS ARE TO BE FINISHED WITH 1/2" GYPSUM BOARD ON 16" OC STUDS.
- 38. ALL BOYS ARE TO BE FINISHED WITH 1/2" GYPSUM BOARD ON 16" OC STUDS.
- 39. ALL GIRLS ARE TO BE FINISHED WITH 1/2" GYPSUM BOARD ON 16" OC STUDS.
- 40. ALL STAFF ARE TO BE FINISHED WITH 1/2" GYPSUM BOARD ON 16" OC STUDS.

FLOOR PLAN LEGEND



IDENTIFICATION STAMP
DIVISION OF THE STATE ARCHIVES
OFFICE OF REGULATION SERVICES
A# 01-117275
AC ____ FLS ____ SS ____

REVISIONS:		DATE
1	DESCRIPTION ADDENDUM 5	2-4

DATE ISSUED:	10/30/2017
PROJECT NO:	2017-4
SCALE:	As Indicated

SHEET NUMBER: AF14

SHEET TITLE:

**BUILDING F
RCP
COMPOSITE
DEMOLITION
PLAN**

[illegible]


SHEET NOTES

- EMITTING: CEILING TO REMAIN AT 8'0" AND LIGHTS TRICKLE ROOM PATCH EXISTING. CUP
CEILING WITH SAME. TOILET PARTITIONS AND WALLS DESTROYED TO LEVEL.
- EXISTING CEILING TO REMAIN AT 8'0" AND GIR SLOTTED ROOF PATCH TO LEVEL. SEE MEETING
NOTES WHERE STEEL COLUMN AND WALL DESTROYED DURING
- WORK. EXISTING CEILING TO REMAIN AT 8'0" AND GIR SLOTTED ROOF PATCH TO LEVEL. SEE MEETING
NOTES WHERE STEEL COLUMN AND WALL DESTROYED DURING
- WORK. EXISTING CEILING TO REMAIN AT 8'0" AND GIR SLOTTED ROOF PATCH TO LEVEL. SEE MEETING
NOTES WHERE STEEL COLUMN AND WALL DESTROYED DURING

BUILDING F COMPOSITE DEMOLITION KEY NOTES

- [illegible]

1. **STAFF**
2. **PROGRAM** (DESIGN, COUNSELING, TRAINING, RESEARCH, EVALUATION, AND
3. **ADMINISTRATION**)
4. **PERSONNEL** (COUNSELORS, RESEARCHERS, EVALUATORS, TRAINERS, AND
5. **ADMINISTRATORS**)
6. **CLIENTS** (INDIVIDUALS, GROUPS, AND COMMUNITIES)
7. **PROBLEMS** (MENTAL, BEHAVIORAL, AND SOCIAL)
8. **THEORY** (PSYCHOLOGICAL, EDUCATIONAL, AND SOCIAL)
9. **RESEARCH** (QUANTITATIVE, QUALITATIVE, AND MIXED)
10. **EVALUATION** (FORMATIVE, SUMMATIVE, AND PROCESS)
11. **TRAINING** (INDIVIDUAL, GROUP, AND COMMUNITY)
12. **ADMINISTRATION** (MANAGEMENT, FINANCE, AND POLICY)
13. **ETHICS** (PROFESSIONAL, RESEARCH, AND HUMAN RIGHTS)
14. **LEGISLATION** (FEDERAL, STATE, AND LOCAL)
15. **TECHNOLOGY** (COMPUTER, TELEPHONE, AND VIDEO)
16. **COMMUNITY** (URBAN, SUBURBAN, AND RURAL)
17. **CULTURE** (RACE, ETHNICITY, AND RELIGION)
18. **ENVIRONMENT** (PHYSICAL, SOCIAL, AND CULTURAL)
19. **SYSTEMS** (HEALTH, EDUCATION, AND SOCIAL SERVICES)
20. **IMPACT** (INDIVIDUAL, COMMUNITY, AND SOCIETY)

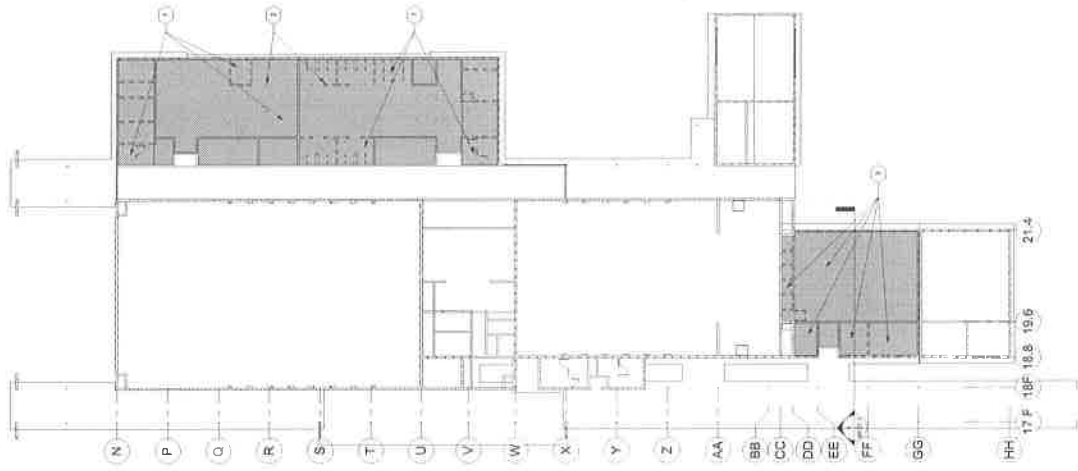



IDENTIFICATION STAMP
DIVISION OF THE STATE ARCHIVES
OFFICE OF REGULATION SERVICES
A# 01-117275
AC PLS SS

[illegible]

DATE ISSUED:	10/30/2017
PROJECT NO:	2017-4
SCALE:	As indicated

SHEET NUMBER: AF14

SHEET TITLE:

**BUILDING F
RCP
COMPOSITE
IMPROVEMENT
PLAN**




SHEET NOTES

- 1 PATCH AND JAMB EXISTING CRACKS BOARD FEELING WHERE ALL WALLS AND PARTITIONS BRACKLING OCCURRED
- 2 PATCH AND PAINT EXISTING CRACKS IN BOARD FEELING WHERE STEEL COLLARS AND WALL COLLIMENTS REQUIRED
- 3 NEW INTRIGUE OF MECHANICAL ELECTRICAL PLUMBING IN WORKING AND EDUCATIONAL REFORMATION
- 4 SUSPENSION OF LIGHT FIXTURES, SET FLECTRICITY DRAWINGS


BUILDING FRCP KEY NOTES

- [illegible]

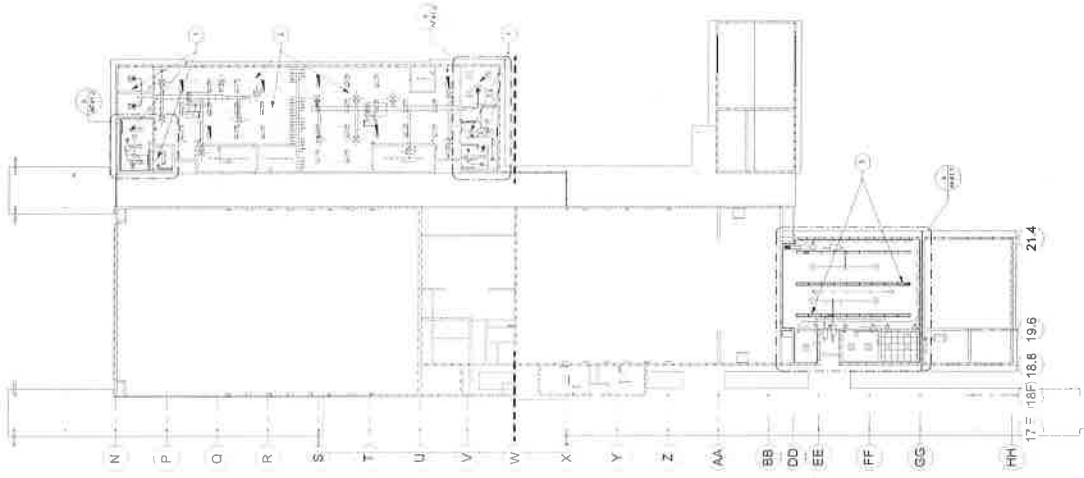
[illegible]

06:41:00 A
06:42:18 A
06:43:00 A
06:45:00 A
06:50:00 B
06:55:00 C
07:00:00 A

KEYNOTES

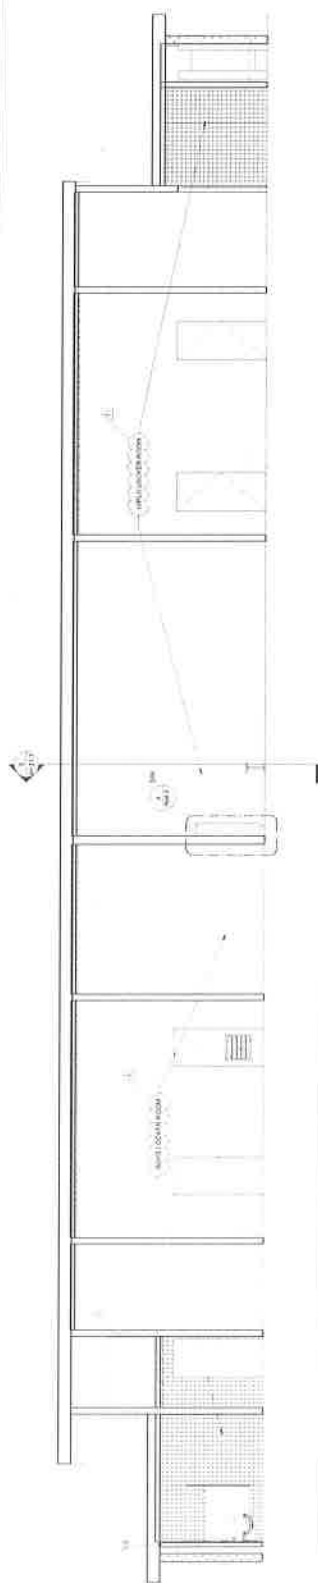


LOCKER ROOMS BUILDING SECTION 4

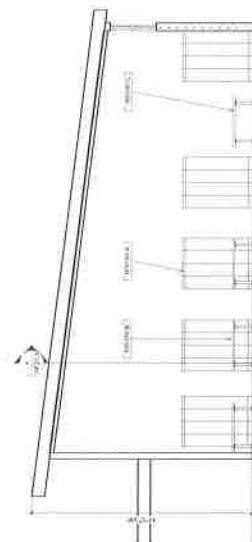

See 21 and 22/AF-4: 2 for additional dimensions on accessibility

LOCKER ROOM BUILDING SECTION 3

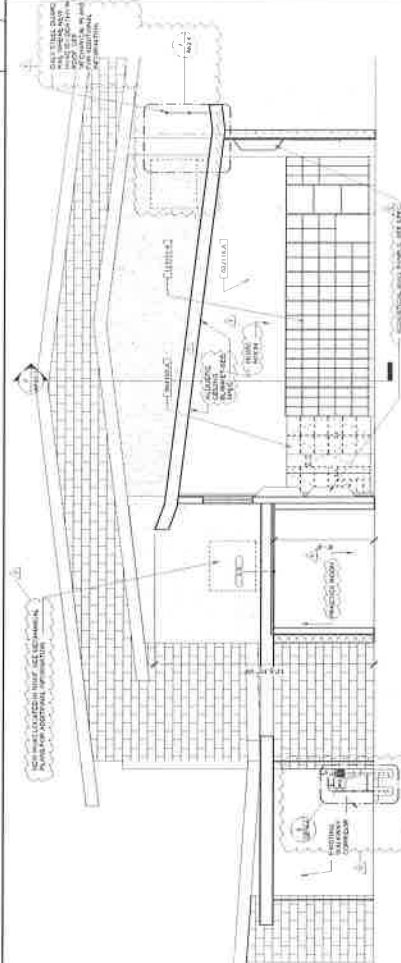

MUSIC ROOM BUILDING SECTION 1

OWNER: RAVENSWOOD CITY SCHOOL DISTRICT
PROJECT NAME: RAVENSWOOD MS REALIGNMENT PHASE 1
CLIENT ADDRESS: 2120 EUCLID AVENUE EAST PALO ALTO, CA 94303

IDENTIFICATION STAMP
DIVISION OF THE STATE ARCHIVES
OFFICE OF REGULATION & ADMINISTRATION
#01-117275

REVISIONS	DESCRIPTION	DATE
1	ADDED QAM	2-1-7

DATE ISSUED:	10/30/17
PROJECT NO:	2017-41
SCALE:	1/4" = 1'

SHEET NUMBER: AF31

BUILDING F
BUILDING
SECTIONS

[illegible]

SHEET NOTES

201 JANUARY 25-16:22

RECEIVED BY THE U.S. DEPARTMENT OF THE ARMY

WAS MONITORING OPERATIONS IN THE 37TH INFANTRY

SUBJECT: MOUNTAIN AREA, IN THE 37TH INFANTRY

SUBJECT: MOUNTAIN AREA, IN THE 37TH INFANTRY

SUBJECT: MOUNTAIN AREA, IN THE 37TH INFANTRY

STAFFS OF REGIONAL PLANNING

1967-1970

DR. BURG LEUNG, RESIDENT, NOTE 1

ANSWERS:

1. CRYSTAL TEMPLATES SERVED AS NUCLEI FOR FRAMING INITIATION. HOSTS: LIND
2. POLYMERIZATION OF MONOMER CRYSTALS TO POLYMER
3. INITIATED
4. POLYMERIZATION OF MONOMER CRYSTALS TO POLYMER
5. POLYMERIZATION OF MONOMER CRYSTALS TO POLYMER
6. POLYMERIZATION OF MONOMER CRYSTALS TO POLYMER
7. POLYMERIZATION OF MONOMER CRYSTALS TO POLYMER
8. POLYMERIZATION OF MONOMER CRYSTALS TO POLYMER
9. POLYMERIZATION OF MONOMER CRYSTALS TO POLYMER
10. POLYMERIZATION OF MONOMER CRYSTALS TO POLYMER

RCP LEGEND

REFER TO ELECTRICAL DRAWINGS FOR LOCATIONS OF EMERGENCY LIGHTING
IN SEE TYPICAL FLOOR PLAN. PATTERNS

CONDUITS, DISTRIBUTION PANELS, AND FIRE PROTECTION EQUIPMENT,
AND SMOKE/FIRE RETARDANT AND CUMULATIVE PRODUCTS REFER TO
DRAWING ELEC-01 FOR DETAILS. ALL INSTALLATION SHALL BE IN ACCORDANCE WITH THE
LATEST EDITIONS OF THE NATIONAL ELECTRICAL CODE (NEC) AND THE
NATIONAL FIRE PROTECTION ASSOCIATION (NFPA) STANDARDS.
ALL WORK SHALL BE DONE IN ACCORDANCE WITH THE LATEST EDITIONS OF THE
NATIONAL ELECTRICAL CODE (NEC) AND THE NATIONAL FIRE PROTECTION
ASSOCIATION (NFPA) STANDARDS.

207467 N. ACE-2500 C MULTI C 1000
1.640 1.100 0.900 0.700

207468 N. ACE-2500 C 1000 C 1000
0.700 1.100 0.900 1.640










100% POLYESTER WALL
 EASY TO HANG
 REINFORCED WALL (SPECIAL PAINT)
 100% 220G SM. 100% 100% 100%
 100% 100% 100%
 100% 100% 100%
 WALL PAPER MONOTONICS, SEE SOCIETY

[illegible]

FLOOR PLAN LEGEND

Architectural floor plan of the second floor of the Music Building. The plan shows a large central hall (HALLWAY) with a north arrow pointing towards the top right. To the left of the hallway are two rooms: MUSIC STUDIO (F1, 14 SF) and MUSIC STUDIO (F2, 14 SF). To the right of the hallway are two rooms: PRACTICE RM 1 (F4, 108 SF) and PRACTICE RM 2 (F5, 108 SF). At the top of the plan is a large room labeled MUSIC PRACTICE (F3, 1213 SF). At the bottom left is a room labeled Room 322 (38 SF). The plan includes various doors, windows, and structural elements like columns and walls. Dimensions are provided for the overall building footprint and individual rooms.

[illegible][illegible]

MUSIC ROOM INTERIOR ELEVATION S		5' 0" x 10' 0"	5

OWNER: RAVENSWOOD CITY SCHOOL
 DISTRICT
 PROJECT NAME: RAVENSWOOD MS
 REALIGNMENT PHASE 1

CUSTOMER ADDRESS: 2120 EUCLID AVENUE EAST PALO ALTO, CA 94303



IDENTIFICATION STAMP
 PROJECT NO. 15-0001
 DATE 01-11-2015
 AC 01-11-2015

DATE

REVISIONS	DESCRIPTION	DATE
1	AS SHOWN	01-11-2015

DATE ISSUED: 01-11-2015
 PROJECT NO. 15-0001
 SCALE: AS SHOWN

SHEET NUMBER: AF41
 SHEET TITLE:

BUILDING F
 ENLARGED
 RESTROOM
 PLANS



- REVISIONS**
- 1. TO CORRECT FROM PREVIOUS SET FOR THE NEW
 - 2. TO CORRECT FROM PREVIOUS SET FOR THE NEW
 - 3. TO CORRECT FROM PREVIOUS SET FOR THE NEW
 - 4. TO CORRECT FROM PREVIOUS SET FOR THE NEW
 - 5. TO CORRECT FROM PREVIOUS SET FOR THE NEW
 - 6. TO CORRECT FROM PREVIOUS SET FOR THE NEW
 - 7. TO CORRECT FROM PREVIOUS SET FOR THE NEW
 - 8. TO CORRECT FROM PREVIOUS SET FOR THE NEW
 - 9. TO CORRECT FROM PREVIOUS SET FOR THE NEW
 - 10. TO CORRECT FROM PREVIOUS SET FOR THE NEW
 - 11. TO CORRECT FROM PREVIOUS SET FOR THE NEW
 - 12. TO CORRECT FROM PREVIOUS SET FOR THE NEW
 - 13. TO CORRECT FROM PREVIOUS SET FOR THE NEW
 - 14. TO CORRECT FROM PREVIOUS SET FOR THE NEW
 - 15. TO CORRECT FROM PREVIOUS SET FOR THE NEW
 - 16. TO CORRECT FROM PREVIOUS SET FOR THE NEW
 - 17. TO CORRECT FROM PREVIOUS SET FOR THE NEW
 - 18. TO CORRECT FROM PREVIOUS SET FOR THE NEW
 - 19. TO CORRECT FROM PREVIOUS SET FOR THE NEW
 - 20. TO CORRECT FROM PREVIOUS SET FOR THE NEW
 - 21. TO CORRECT FROM PREVIOUS SET FOR THE NEW
 - 22. TO CORRECT FROM PREVIOUS SET FOR THE NEW
 - 23. TO CORRECT FROM PREVIOUS SET FOR THE NEW

SHEET NOTES


1. ALL DIMENSIONS ARE IN FEET AND INCHES. DIMENSIONS IN PARENTHESES ARE IN METERS.
2. ALL DIMENSIONS ARE TO FACE UNLESS OTHERWISE NOTED.
3. ALL DIMENSIONS ARE TO FACE UNLESS OTHERWISE NOTED.
4. ALL DIMENSIONS ARE TO FACE UNLESS OTHERWISE NOTED.
5. ALL DIMENSIONS ARE TO FACE UNLESS OTHERWISE NOTED.
6. ALL DIMENSIONS ARE TO FACE UNLESS OTHERWISE NOTED.
7. ALL DIMENSIONS ARE TO FACE UNLESS OTHERWISE NOTED.
8. ALL DIMENSIONS ARE TO FACE UNLESS OTHERWISE NOTED.
9. ALL DIMENSIONS ARE TO FACE UNLESS OTHERWISE NOTED.
10. ALL DIMENSIONS ARE TO FACE UNLESS OTHERWISE NOTED.
11. ALL DIMENSIONS ARE TO FACE UNLESS OTHERWISE NOTED.
12. ALL DIMENSIONS ARE TO FACE UNLESS OTHERWISE NOTED.
13. ALL DIMENSIONS ARE TO FACE UNLESS OTHERWISE NOTED.
14. ALL DIMENSIONS ARE TO FACE UNLESS OTHERWISE NOTED.
15. ALL DIMENSIONS ARE TO FACE UNLESS OTHERWISE NOTED.
16. ALL DIMENSIONS ARE TO FACE UNLESS OTHERWISE NOTED.
17. ALL DIMENSIONS ARE TO FACE UNLESS OTHERWISE NOTED.
18. ALL DIMENSIONS ARE TO FACE UNLESS OTHERWISE NOTED.
19. ALL DIMENSIONS ARE TO FACE UNLESS OTHERWISE NOTED.
20. ALL DIMENSIONS ARE TO FACE UNLESS OTHERWISE NOTED.
21. ALL DIMENSIONS ARE TO FACE UNLESS OTHERWISE NOTED.
22. ALL DIMENSIONS ARE TO FACE UNLESS OTHERWISE NOTED.
23. ALL DIMENSIONS ARE TO FACE UNLESS OTHERWISE NOTED.

NOTES


1. THE ENLARGED RESTROOMS SHALL BE FINISHED WITH 12" X 12" POLISHED PORCELAIN TILE.
2. THE ENLARGED RESTROOMS SHALL BE FINISHED WITH 12" X 12" POLISHED PORCELAIN TILE.
3. THE ENLARGED RESTROOMS SHALL BE FINISHED WITH 12" X 12" POLISHED PORCELAIN TILE.
4. THE ENLARGED RESTROOMS SHALL BE FINISHED WITH 12" X 12" POLISHED PORCELAIN TILE.
5. THE ENLARGED RESTROOMS SHALL BE FINISHED WITH 12" X 12" POLISHED PORCELAIN TILE.
6. THE ENLARGED RESTROOMS SHALL BE FINISHED WITH 12" X 12" POLISHED PORCELAIN TILE.
7. THE ENLARGED RESTROOMS SHALL BE FINISHED WITH 12" X 12" POLISHED PORCELAIN TILE.
8. THE ENLARGED RESTROOMS SHALL BE FINISHED WITH 12" X 12" POLISHED PORCELAIN TILE.
9. THE ENLARGED RESTROOMS SHALL BE FINISHED WITH 12" X 12" POLISHED PORCELAIN TILE.
10. THE ENLARGED RESTROOMS SHALL BE FINISHED WITH 12" X 12" POLISHED PORCELAIN TILE.
11. THE ENLARGED RESTROOMS SHALL BE FINISHED WITH 12" X 12" POLISHED PORCELAIN TILE.
12. THE ENLARGED RESTROOMS SHALL BE FINISHED WITH 12" X 12" POLISHED PORCELAIN TILE.
13. THE ENLARGED RESTROOMS SHALL BE FINISHED WITH 12" X 12" POLISHED PORCELAIN TILE.
14. THE ENLARGED RESTROOMS SHALL BE FINISHED WITH 12" X 12" POLISHED PORCELAIN TILE.
15. THE ENLARGED RESTROOMS SHALL BE FINISHED WITH 12" X 12" POLISHED PORCELAIN TILE.
16. THE ENLARGED RESTROOMS SHALL BE FINISHED WITH 12" X 12" POLISHED PORCELAIN TILE.
17. THE ENLARGED RESTROOMS SHALL BE FINISHED WITH 12" X 12" POLISHED PORCELAIN TILE.
18. THE ENLARGED RESTROOMS SHALL BE FINISHED WITH 12" X 12" POLISHED PORCELAIN TILE.
19. THE ENLARGED RESTROOMS SHALL BE FINISHED WITH 12" X 12" POLISHED PORCELAIN TILE.
20. THE ENLARGED RESTROOMS SHALL BE FINISHED WITH 12" X 12" POLISHED PORCELAIN TILE.
21. THE ENLARGED RESTROOMS SHALL BE FINISHED WITH 12" X 12" POLISHED PORCELAIN TILE.
22. THE ENLARGED RESTROOMS SHALL BE FINISHED WITH 12" X 12" POLISHED PORCELAIN TILE.
23. THE ENLARGED RESTROOMS SHALL BE FINISHED WITH 12" X 12" POLISHED PORCELAIN TILE.

RCP LEGEND


- 1. 12" X 12" POLISHED PORCELAIN TILE
- 2. 12" X 12" POLISHED PORCELAIN TILE
- 3. 12" X 12" POLISHED PORCELAIN TILE
- 4. 12" X 12" POLISHED PORCELAIN TILE
- 5. 12" X 12" POLISHED PORCELAIN TILE
- 6. 12" X 12" POLISHED PORCELAIN TILE
- 7. 12" X 12" POLISHED PORCELAIN TILE
- 8. 12" X 12" POLISHED PORCELAIN TILE
- 9. 12" X 12" POLISHED PORCELAIN TILE
- 10. 12" X 12" POLISHED PORCELAIN TILE
- 11. 12" X 12" POLISHED PORCELAIN TILE
- 12. 12" X 12" POLISHED PORCELAIN TILE
- 13. 12" X 12" POLISHED PORCELAIN TILE
- 14. 12" X 12" POLISHED PORCELAIN TILE
- 15. 12" X 12" POLISHED PORCELAIN TILE
- 16. 12" X 12" POLISHED PORCELAIN TILE
- 17. 12" X 12" POLISHED PORCELAIN TILE
- 18. 12" X 12" POLISHED PORCELAIN TILE
- 19. 12" X 12" POLISHED PORCELAIN TILE
- 20. 12" X 12" POLISHED PORCELAIN TILE
- 21. 12" X 12" POLISHED PORCELAIN TILE
- 22. 12" X 12" POLISHED PORCELAIN TILE
- 23. 12" X 12" POLISHED PORCELAIN TILE

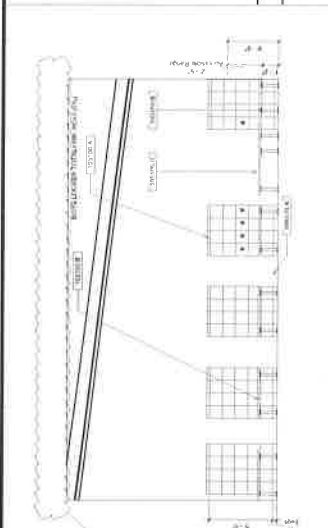


BOYS LOCKER

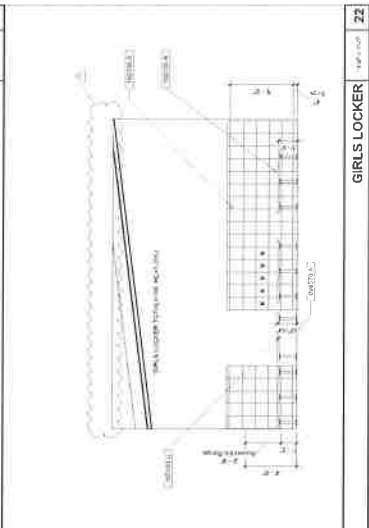


GIRLS LOCKER

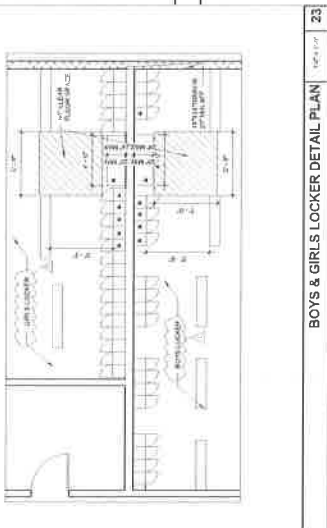


BOYS & GIRLS LOCKER DETAIL PLAN

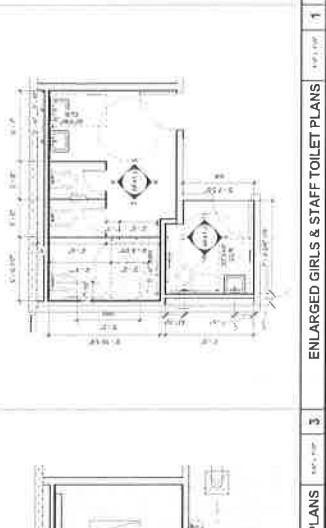

ENLARGED GIRLS & STAFF TOILET PLANS

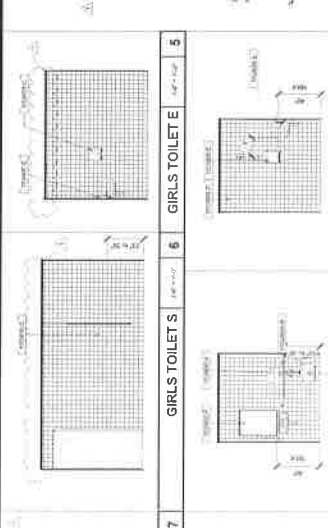


GIRLS TOILET E

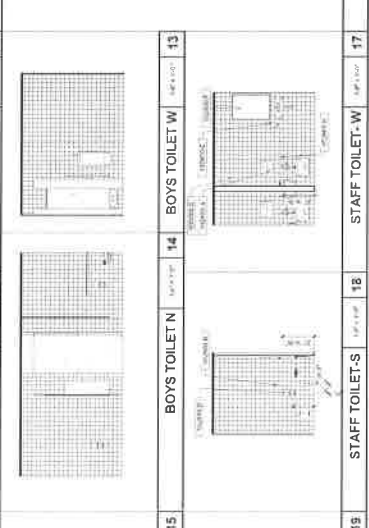


GIRLS TOILET S




BOYS TOILET W

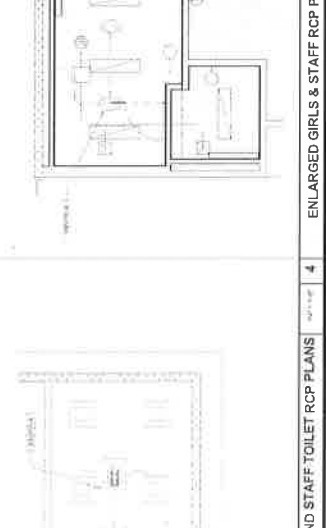


BOYS TOILET N

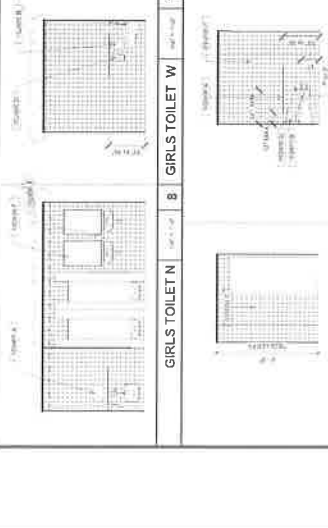


BOYS TOILET E

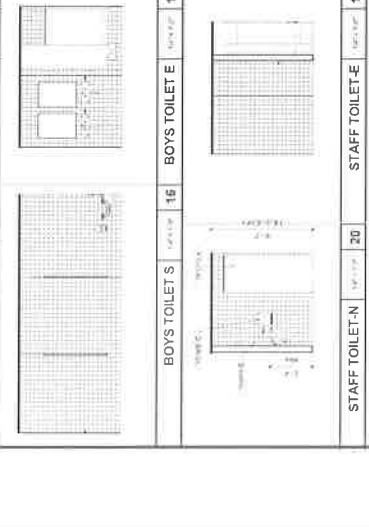

BOYS TOILET S

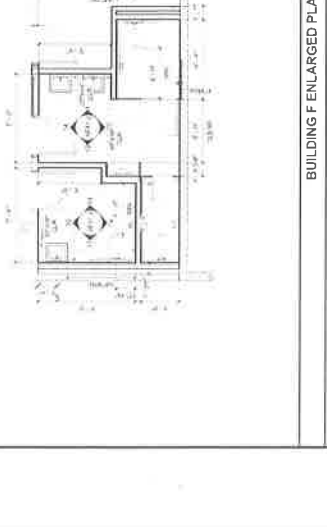

STAFF TOILET E

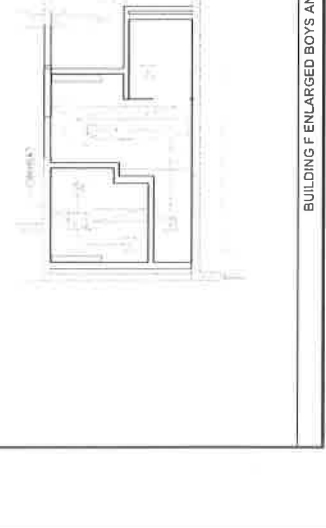

STAFF TOILET S

OWNER: RAVENSWOOD CITY SCHOOL
DISTRICT
PROJECT NAME: RAVENSWOOD MS
REALIGNMENT PHASE 1
CLIENT ADDRESS: 2120 EUCLID AVENUE EAST PALO ALTO, CA 94303



IDENTIFICATION STAMP
OFFICE OF REGISTRATION
ARCHITECTS
AB 01-17275
DATE: 10/1/2017

REVISIONS	DESCRIPTION	DATE
1	ADDITIONAL	2-4-17

DATE ISSUED: 10/20/17
PROJECT NO: 2017-41
SCALE: AS SHOWN

SHEET NUMBER: A50
SHEET TITLE: INTERIOR FINISH SCHEDULE


INTERIOR FINISH SCHEDULE



Room Number	Room Name	Finish Description	Color Code	Comments
BUILDING A				
A1	ENTRANCE	W-1	W-1	ACT-2
A2	RECEPTION	W-1	W-1	ACT-2
A3	CLASSROOM	W-1	W-1	ACT-2
A4	CLASSROOM	W-1	W-1	ACT-2
A5	CLASSROOM	W-1	W-1	ACT-2
A6	CLASSROOM	W-1	W-1	ACT-2
A7	CLASSROOM	W-1	W-1	ACT-2
A8	CLASSROOM	W-1	W-1	ACT-2
A9	CLASSROOM	W-1	W-1	ACT-2
A10	CLASSROOM	W-1	W-1	ACT-2
A11	CLASSROOM	W-1	W-1	ACT-2
A12	CLASSROOM	W-1	W-1	ACT-2
A13	CLASSROOM	W-1	W-1	ACT-2
A14	CLASSROOM	W-1	W-1	ACT-2
A15	CLASSROOM	W-1	W-1	ACT-2
A16	CLASSROOM	W-1	W-1	ACT-2
A17	CLASSROOM	W-1	W-1	ACT-2
A18	CLASSROOM	W-1	W-1	ACT-2
A19	CLASSROOM	W-1	W-1	ACT-2
A20	CLASSROOM	W-1	W-1	ACT-2
A21	CLASSROOM	W-1	W-1	ACT-2
A22	CLASSROOM	W-1	W-1	ACT-2
A23	CLASSROOM	W-1	W-1	ACT-2
A24	CLASSROOM	W-1	W-1	ACT-2
A25	CLASSROOM	W-1	W-1	ACT-2
A26	CLASSROOM	W-1	W-1	ACT-2
A27	CLASSROOM	W-1	W-1	ACT-2
A28	CLASSROOM	W-1	W-1	ACT-2
A29	CLASSROOM	W-1	W-1	ACT-2
A30	CLASSROOM	W-1	W-1	ACT-2
A31	CLASSROOM	W-1	W-1	ACT-2
A32	CLASSROOM	W-1	W-1	ACT-2
A33	CLASSROOM	W-1	W-1	ACT-2
A34	CLASSROOM	W-1	W-1	ACT-2
A35	CLASSROOM	W-1	W-1	ACT-2
A36	CLASSROOM	W-1	W-1	ACT-2
A37	CLASSROOM	W-1	W-1	ACT-2
A38	CLASSROOM	W-1	W-1	ACT-2
A39	CLASSROOM	W-1	W-1	ACT-2
A40	CLASSROOM	W-1	W-1	ACT-2
A41	CLASSROOM	W-1	W-1	ACT-2
A42	CLASSROOM	W-1	W-1	ACT-2
A43	CLASSROOM	W-1	W-1	ACT-2
A44	CLASSROOM	W-1	W-1	ACT-2
A45	CLASSROOM	W-1	W-1	ACT-2
A46	CLASSROOM	W-1	W-1	ACT-2
A47	CLASSROOM	W-1	W-1	ACT-2
A48	CLASSROOM	W-1	W-1	ACT-2
A49	CLASSROOM	W-1	W-1	ACT-2
A50	CLASSROOM	W-1	W-1	ACT-2

1	WALLS	W-1	W-1	ACT-2
2	WALLS	W-1	W-1	ACT-2
3	WALLS	W-1	W-1	ACT-2
100	WALLS	W-1	W-1	ACT-2

1	MILLWORK	W-1	W-1	ACT-2
2	MILLWORK	W-1	W-1	ACT-2
3	MILLWORK	W-1	W-1	ACT-2
100	MILLWORK	W-1	W-1	ACT-2

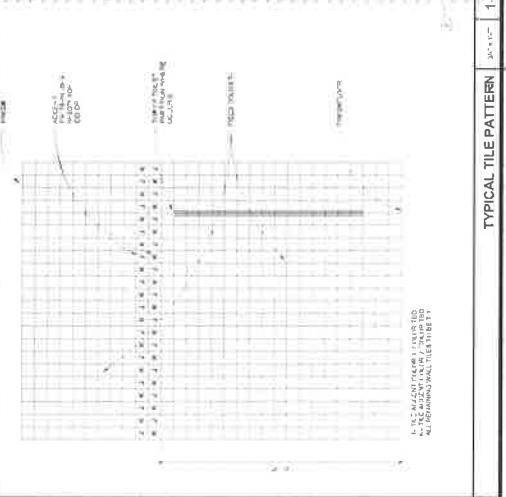

1	CEILING	W-1	W-1	ACT-2
2	CEILING	W-1	W-1	ACT-2
3	CEILING	W-1	W-1	ACT-2
4	CEILING	W-1	W-1	ACT-2
5	CEILING	W-1	W-1	ACT-2
6	CEILING	W-1	W-1	ACT-2
7	CEILING	W-1	W-1	ACT-2
8	CEILING	W-1	W-1	ACT-2
9	CEILING	W-1	W-1	ACT-2
10	CEILING	W-1	W-1	ACT-2
11	CEILING	W-1	W-1	ACT-2
12	CEILING	W-1	W-1	ACT-2
13	CEILING	W-1	W-1	ACT-2
14	CEILING	W-1	W-1	ACT-2
15	CEILING	W-1	W-1	ACT-2
16	CEILING	W-1	W-1	ACT-2
17	CEILING	W-1	W-1	ACT-2
18	CEILING	W-1	W-1	ACT-2
19	CEILING	W-1	W-1	ACT-2
20	CEILING	W-1	W-1	ACT-2
21	CEILING	W-1	W-1	ACT-2
22	CEILING	W-1	W-1	ACT-2
23	CEILING	W-1	W-1	ACT-2
24	CEILING	W-1	W-1	ACT-2
25	CEILING	W-1	W-1	ACT-2
26	CEILING	W-1	W-1	ACT-2

OWNER: RAVENSWOOD CITY SCHOOL
 DISTRICT
 PROJECT NAME: RAVENSWOOD MS
 REALIGNMENT PHASE 1
 CLIENT ADDRESS: 2120 EUCLID AVENUE EAST PALO ALTO, CA 94303



IDENTIFICATION STAMP
 ARCHITECT
 OFFICE OF REGULATION
 DATE 01-11-2015

REVISIONS	DESCRIPTION	DATE
1	ADDED DETAILS	01-11-2015

DATE ISSUED: 10-20-15
 PROJECT NO: 2017-41
 SCALE: 3/4" = 1'-0"

SHEET NUMBER: A50
 SHEET TITLE:

DOOR & WINDOW DETAILS



<p>NEW LIGHT FIXTURE - SEE ELECTRICAL DRAWINGS NEW ALTERED AND DOWNSPOUT PAINTED TYPICAL</p>	<p>HEAD WINDOW SHADE DETAIL</p>	<p>HOLLOW METAL FRAME @ INTERIOR</p>	<p>HOLLOW METAL HEAD @ EXTERIOR</p>	<p>HOLLOW METAL JAMB @ EXTERIOR</p>
<p>WINDOW JAMB @ 3X6 COLUMN</p>	<p>WINDOW JAMB @ 6X6 COLUMN</p>	<p>WINDOW JAMB @ PLASTER</p>	<p>WINDOW HEAD @ PLASTER</p>	<p>WINDOW SILL @ PLASTER</p>
<p>LOUVER HEAD @ PLASTER</p>	<p>LOUVER HEAD @ PLASTER</p>	<p>LOUVER HEAD @ PLASTER</p>	<p>LOUVER HEAD @ PLASTER</p>	<p>LOUVER HEAD @ PLASTER</p>
<p>WINDOW SILL @ CMU WALL</p>	<p>WINDOW SILL @ CMU WALL</p>	<p>WINDOW SILL @ CMU WALL</p>	<p>WINDOW HEAD @ HW DOOR</p>	<p>WINDOW JAMB @ HW DOOR</p>

OWNER: RAVENSWOOD CITY SCHOOL DISTRICT
PROJECT NAME: RAVENSWOOD MS REALIGNMENT PHASE 1
CLIENT ADDRESS: 2120 EUCLID AVENUE EAST PALO ALTO, CA 94303

Robert M. Johnson

IDENTIFICATION STAMP
DIVISION OF THE STATE ARCHIVES
OFFICE OF REGULATION SERVICES
A# 01-117275
AC - - - - FLS - - - - SS - - - -

DATE _____

[illegible]

DATE ISSUED	10/30/21
PROJECT NO.	2021-01
SCALE	1"=1'-0"

SHEET NUMBER: _____
SHEET TITLE: _____



WINDOW
OPENING
SCHEDULE

Window Schedule									
TYPE	DATE	WIDTH	HEIGHT	GLASS MATERIAL	FRAME	GLASS	PAINT	FINISH	REMARKS
A	2'-0" x 3'-0"	AL	4'-0" x 3'-0"	AN	SEE SPEC	11-55-2	11-55-2	11-55-2	WINDOW
B	2'-0" x 3'-0"	AL	4'-0" x 3'-0"	AN	SEE SPEC	11-55-2	11-55-2	11-55-2	WINDOW
C	2'-0" x 3'-0"	AL	4'-0" x 3'-0"	AN	SEE SPEC	11-55-2	11-55-2	11-55-2	WINDOW
D	2'-0" x 3'-0"	AL	4'-0" x 3'-0"	AN	SEE SPEC	11-55-2	11-55-2	11-55-2	WINDOW



Activity	Activity	Activity
1. <input type="checkbox"/> 1. <input type="checkbox"/> 1. <input type="checkbox"/>	2. <input type="checkbox"/> 2. <input type="checkbox"/> 2. <input type="checkbox"/>	3. <input type="checkbox"/> 3. <input type="checkbox"/> 3. <input type="checkbox"/>
4. <input type="checkbox"/> 4. <input type="checkbox"/> 4. <input type="checkbox"/>	5. <input type="checkbox"/> 5. <input type="checkbox"/> 5. <input type="checkbox"/>	6. <input type="checkbox"/> 6. <input type="checkbox"/> 6. <input type="checkbox"/>
7. <input type="checkbox"/> 7. <input type="checkbox"/> 7. <input type="checkbox"/>	8. <input type="checkbox"/> 8. <input type="checkbox"/> 8. <input type="checkbox"/>	9. <input type="checkbox"/> 9. <input type="checkbox"/> 9. <input type="checkbox"/>
10. <input type="checkbox"/> 10. <input type="checkbox"/> 10. <input type="checkbox"/>	11. <input type="checkbox"/> 11. <input type="checkbox"/> 11. <input type="checkbox"/>	12. <input type="checkbox"/> 12. <input type="checkbox"/> 12. <input type="checkbox"/>
13. <input type="checkbox"/> 13. <input type="checkbox"/> 13. <input type="checkbox"/>	14. <input type="checkbox"/> 14. <input type="checkbox"/> 14. <input type="checkbox"/>	15. <input type="checkbox"/> 15. <input type="checkbox"/> 15. <input type="checkbox"/>
16. <input type="checkbox"/> 16. <input type="checkbox"/> 16. <input type="checkbox"/>	17. <input type="checkbox"/> 17. <input type="checkbox"/> 17. <input type="checkbox"/>	18. <input type="checkbox"/> 18. <input type="checkbox"/> 18. <input type="checkbox"/>
19. <input type="checkbox"/> 19. <input type="checkbox"/> 19. <input type="checkbox"/>	20. <input type="checkbox"/> 20. <input type="checkbox"/> 20. <input type="checkbox"/>	21. <input type="checkbox"/> 21. <input type="checkbox"/> 21. <input type="checkbox"/>
22. <input type="checkbox"/> 22. <input type="checkbox"/> 22. <input type="checkbox"/>	23. <input type="checkbox"/> 23. <input type="checkbox"/> 23. <input type="checkbox"/>	24. <input type="checkbox"/> 24. <input type="checkbox"/> 24. <input type="checkbox"/>
25. <input type="checkbox"/> 25. <input type="checkbox"/> 25. <input type="checkbox"/>	26. <input type="checkbox"/> 26. <input type="checkbox"/> 26. <input type="checkbox"/>	27. <input type="checkbox"/> 27. <input type="checkbox"/> 27. <input type="checkbox"/>
28. <input type="checkbox"/> 28. <input type="checkbox"/> 28. <input type="checkbox"/>	29. <input type="checkbox"/> 29. <input type="checkbox"/> 29. <input type="checkbox"/>	30. <input type="checkbox"/> 30. <input type="checkbox"/> 30. <input type="checkbox"/>
31. <input type="checkbox"/> 31. <input type="checkbox"/> 31. <input type="checkbox"/>	32. <input type="checkbox"/> 32. <input type="checkbox"/> 32. <input type="checkbox"/>	33. <input type="checkbox"/> 33. <input type="checkbox"/> 33. <input type="checkbox"/>
34. <input type="checkbox"/> 34. <input type="checkbox"/> 34. <input type="checkbox"/>	35. <input type="checkbox"/> 35. <input type="checkbox"/> 35. <input type="checkbox"/>	36. <input type="checkbox"/> 36. <input type="checkbox"/> 36. <input type="checkbox"/>
37. <input type="checkbox"/> 37. <input type="checkbox"/> 37. <input type="checkbox"/>	38. <input type="checkbox"/> 38. <input type="checkbox"/> 38. <input type="checkbox"/>	39. <input type="checkbox"/> 39. <input type="checkbox"/> 39. <input type="checkbox"/>
40. <input type="checkbox"/> 40. <input type="checkbox"/> 40. <input type="checkbox"/>	41. <input type="checkbox"/> 41. <input type="checkbox"/> 41. <input type="checkbox"/>	42. <input type="checkbox"/> 42. <input type="checkbox"/> 42. <input type="checkbox"/>
43. <input type="checkbox"/> 43. <input type="checkbox"/> 43. <input type="checkbox"/>	44. <input type="checkbox"/> 44. <input type="checkbox"/> 44. <input type="checkbox"/>	45. <input type="checkbox"/> 45. <input type="checkbox"/> 45. <input type="checkbox"/>
46. <input type="checkbox"/> 46. <input type="checkbox"/> 46. <input type="checkbox"/>	47. <input type="checkbox"/> 47. <input type="checkbox"/> 47. <input type="checkbox"/>	48. <input type="checkbox"/> 48. <input type="checkbox"/> 48. <input type="checkbox"/>
49. <input type="checkbox"/> 49. <input type="checkbox"/> 49. <input type="checkbox"/>	50. <input type="checkbox"/> 50. <input type="checkbox"/> 50. <input type="checkbox"/>	51. <input type="checkbox"/> 51. <input type="checkbox"/> 51. <input type="checkbox"/>
52. <input type="checkbox"/> 52. <input type="checkbox"/> 52. <input type="checkbox"/>	53. <input type="checkbox"/> 53. <input type="checkbox"/> 53. <input type="checkbox"/>	54. <input type="checkbox"/> 54. <input type="checkbox"/> 54. <input type="checkbox"/>
55. <input type="checkbox"/> 55. <input type="checkbox"/> 55. <input type="checkbox"/>	56. <input type="checkbox"/> 56. <input type="checkbox"/> 56. <input type="checkbox"/>	57. <input type="checkbox"/> 57. <input type="checkbox"/> 57. <input type="checkbox"/>
58. <input type="checkbox"/> 58. <input type="checkbox"/> 58. <input type="checkbox"/>	59. <input type="checkbox"/> 59. <input type="checkbox"/> 59. <input type="checkbox"/>	60. <input type="checkbox"/> 60. <input type="checkbox"/> 60. <input type="checkbox"/>
61. <input type="checkbox"/> 61. <input type="checkbox"/> 61. <input type="checkbox"/>	62. <input type="checkbox"/> 62. <input type="checkbox"/> 62. <input type="checkbox"/>	63. <input type="checkbox"/> 63. <input type="checkbox"/> 63. <input type="checkbox"/>
64. <input type="checkbox"/> 64. <input type="checkbox"/> 64. <input type="checkbox"/>	65. <input type="checkbox"/> 65. <input type="checkbox"/> 65. <input type="checkbox"/>	66. <input type="checkbox"/> 66. <input type="checkbox"/> 66. <input type="checkbox"/>
67. <input type="checkbox"/> 67. <input type="checkbox"/> 67. <input type="checkbox"/>	68. <input type="checkbox"/> 68. <input type="checkbox"/> 68. <input type="checkbox"/>	69. <input type="checkbox"/> 69. <input type="checkbox"/> 69. <input type="checkbox"/>
70. <input type="checkbox"/> 70. <input type="checkbox"/> 70. <input type="checkbox"/>	71. <input type="checkbox"/> 71. <input type="checkbox"/> 71. <input type="checkbox"/>	72. <input type="checkbox"/> 72. <input type="checkbox"/> 72. <input type="checkbox"/>
73. <input type="checkbox"/> 73. <input type="checkbox"/> 73. <input type="checkbox"/>	74. <input type="checkbox"/> 74. <input type="checkbox"/> 74. <input type="checkbox"/>	75. <input type="checkbox"/> 75. <input type="checkbox"/> 75. <input type="checkbox"/>
76. <input type="checkbox"/> 76. <input type="checkbox"/> 76. <input type="checkbox"/>	77. <input type="checkbox"/> 77. <input type="checkbox"/> 77. <input type="checkbox"/>	78. <input type="checkbox"/> 78. <input type="checkbox"/> 78. <input type="checkbox"/>
79. <input type="checkbox"/> 79. <input type="checkbox"/> 79. <input type="checkbox"/>	80. <input type="checkbox"/> 80. <input type="checkbox"/> 80. <input type="checkbox"/>	81. <input type="checkbox"/> 81. <input type="checkbox"/> 81. <input type="checkbox"/>
82. <input type="checkbox"/> 82. <input type="checkbox"/> 82. <input type="checkbox"/>	83. <input type="checkbox"/> 83. <input type="checkbox"/> 83. <input type="checkbox"/>	84. <input type="checkbox"/> 84. <input type="checkbox"/> 84. <input type="checkbox"/>
85. <input type="checkbox"/> 85. <input type="checkbox"/> 85. <input type="checkbox"/>	86. <input type="checkbox"/> 86. <input type="checkbox"/> 86. <input type="checkbox"/>	87. <input type="checkbox"/> 87. <input type="checkbox"/> 87. <input type="checkbox"/>
88. <input type="checkbox"/> 88. <input type="checkbox"/> 88. <input type="checkbox"/>	89. <input type="checkbox"/> 89. <input type="checkbox"/> 89. <input type="checkbox"/>	90. <input type="checkbox"/> 90. <input type="checkbox"/> 90. <input type="checkbox"/>
91. <input type="checkbox"/> 91. <input type="checkbox"/> 91. <input type="checkbox"/>	92. <input type="checkbox"/> 92. <input type="checkbox"/> 92. <input type="checkbox"/>	93. <input type="checkbox"/> 93. <input type="checkbox"/> 93. <input type="checkbox"/>
94. <input type="checkbox"/> 94. <input type="checkbox"/> 94. <input type="checkbox"/>	95. <input type="checkbox"/> 95. <input type="checkbox"/> 95. <input type="checkbox"/>	96. <input type="checkbox"/> 96. <input type="checkbox"/> 96. <input type="checkbox"/>
97. <input type="checkbox"/> 97. <input type="checkbox"/> 97. <input type="checkbox"/>	98. <input type="checkbox"/> 98. <input type="checkbox"/> 98. <input type="checkbox"/>	99. <input type="checkbox"/> 99. <input type="checkbox"/> 99. <input type="checkbox"/>
100. <input type="checkbox"/> 100. <input type="checkbox"/> 100. <input type="checkbox"/>	101. <input type="checkbox"/> 101. <input type="checkbox"/> 101. <input type="checkbox"/>	102. <input type="checkbox"/> 102. <input type="checkbox"/> 102. <input type="checkbox"/>
103. <input type="checkbox"/> 103. <input type="checkbox"/> 103. <input type="checkbox"/>	104. <input type="checkbox"/> 104. <input type="checkbox"/> 104. <input type="checkbox"/>	105. <input type="checkbox"/> 105. <input type="checkbox"/> 105. <input type="checkbox"/>
106. <input type="checkbox"/> 106. <input type="checkbox"/> 106. <input type="checkbox"/>	107. <input type="checkbox"/> 107. <input type="checkbox"/> 107. <input type="checkbox"/>	108. <input type="checkbox"/> 108. <input type="checkbox"/> 108. <input type="checkbox"/>
109. <input type="checkbox"/> 109. <input type="checkbox"/> 109. <input type="checkbox"/>	110. <input type="checkbox"/> 110. <input type="checkbox"/> 110. <input type="checkbox"/>	111. <input type="checkbox"/> 111. <input type="checkbox"/> 111. <input type="checkbox"/>
112. <		

© 2000 Blackwell Science Ltd
Journal of Internal Medicine 247: 111-117

WINDOW SCHEDULE

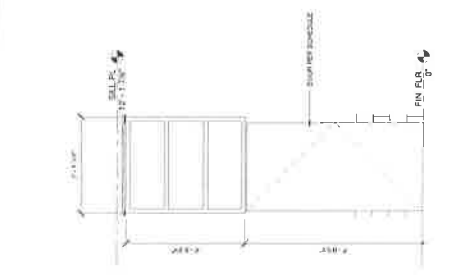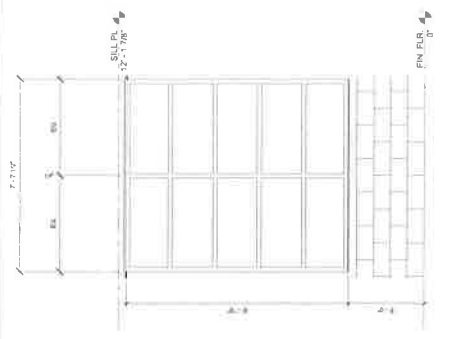

LOUVER TYPE 1

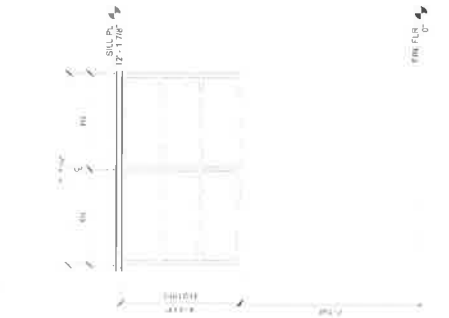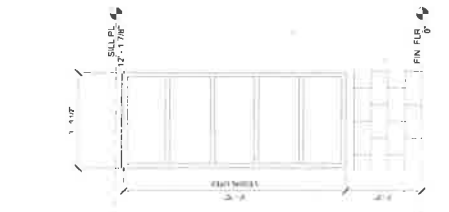

WINDOW TYPE A	WINDOW TYPE B
3	1
4	2
5	3
173	171

1	2	3	100

OWNER: RAVENSWOOD CITY SCHOOL DISTRICT
 PROJECT NAME: RAVENSWOOD MS REALIGNMENT PHASE 1
 CLIENT ADDRESS: 2120 EUCLID AVENUE EAST PALO ALTO, CA 94303




IDENTIFICATION STAMP
 DIVISION OF THE STATE ARCHITECT
 PROJECT NO. 2017-41
 DATE 10/30/17
 SCALE 1/8" = 1'-0"

REVISION	DESCRIPTION	DATE
1	ISSUED FOR PERMIT	10/30/17

SHEET NUMBER A62
 SHEET TITLE: ROOF DETAIL



<p>NOTE: SEE STRUCTURAL DRAWING FOR OPENING FRAMING DETAILS.</p> <p>1 1/8" = 1'-0"</p>	<p>ROOF LARGE OPENING 3-D DETAIL</p> <p>1 1/8" = 1'-0"</p>	<p>ROOF CURB DETAIL</p> <p>1 1/8" = 1'-0"</p>	<p>ROOF PIPE PENETRATION AT SEAM</p> <p>1 1/8" = 1'-0"</p>
<p>NOTE: SEE STRUCTURAL DRAWING FOR OPENING FRAMING DETAILS.</p> <p>1 1/8" = 1'-0"</p>	<p>ROOF CURB DETAIL</p> <p>1 1/8" = 1'-0"</p>	<p>ROOF PIPE PENETRATION AT SEAM</p> <p>1 1/8" = 1'-0"</p>	<p>ROOF PIPE PENETRATION AT SEAM</p> <p>1 1/8" = 1'-0"</p>
<p>ROOF GUARDRAIL AT MECHANICAL UNIT</p> <p>1 1/8" = 1'-0"</p>	<p>ROOF GUARDRAIL AT MECHANICAL UNIT</p> <p>1 1/8" = 1'-0"</p>	<p>ROOF GUARDRAIL AT MECHANICAL UNIT</p> <p>1 1/8" = 1'-0"</p>	<p>ROOF GUARDRAIL AT MECHANICAL UNIT</p> <p>1 1/8" = 1'-0"</p>
<p>ROOF GUARDRAIL AT MECHANICAL UNIT</p> <p>1 1/8" = 1'-0"</p>	<p>ROOF GUARDRAIL AT MECHANICAL UNIT</p> <p>1 1/8" = 1'-0"</p>	<p>ROOF GUARDRAIL AT MECHANICAL UNIT</p> <p>1 1/8" = 1'-0"</p>	<p>ROOF GUARDRAIL AT MECHANICAL UNIT</p> <p>1 1/8" = 1'-0"</p>
<p>ROOF GUARDRAIL AT MECHANICAL UNIT</p> <p>1 1/8" = 1'-0"</p>	<p>ROOF GUARDRAIL AT MECHANICAL UNIT</p> <p>1 1/8" = 1'-0"</p>	<p>ROOF GUARDRAIL AT MECHANICAL UNIT</p> <p>1 1/8" = 1'-0"</p>	<p>ROOF GUARDRAIL AT MECHANICAL UNIT</p> <p>1 1/8" = 1'-0"</p>

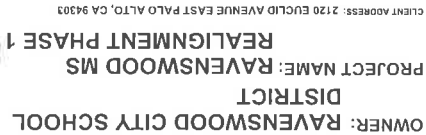

IDENTIFICATION STAMP
DIVISION OF THE STATE ARCHIVES
OFFICE OF REGULATION AND ADMINISTRATION
A# 01-117275

DATE _____

REVISIONS:

NO.	DESCRIPTION	DATE
1	ADDITIONAL 3	2/1/2011

DATE ISSUED:	10/30
PROJECT NO:	2017-4
SCALE:	As indicated

SHEET NUMBER:

SHEET TITLE:

DETAILS



VIBRATION ISOLATOR CURB (HP-F1 & HP-F2)

NOTES

1) --- INDICATES STONE SHOPS
(1) REQUIRED PER ONE SET DETAIL 2
(2) IF THEY ARE LOCATED SEPARATELY SEE DETAIL 2

DATE	NAME	ROOM	NO.	DATE
1966	10/10/66	10/10/66	10/10/66	10/10/66



CALIFORNIA STATE BAR JOURNAL, OCTOBER 1982 • 33




HEAT PUMP WALL COVER DETAIL




TION ISOLATOR CURB TOP VIEW (HP-F1 & HP-F2)


- REMODEL NOTES**
1. SEE TO TOP OF HVC CHASE AT 20'0" BOUND ACCESS PANEL.
 2. 1/2" TAMP PAPER LINC TO FLOOR SINK & FLOOR DRAIN.
 3. HATCH WITH SHUT-OFF VALVE ABOVE CEILING BOUND ACCESS PANEL.
 4. 1/2" HATCH ON WITH SHUT-OFF VALVE.
 5. 1/2" HATCH ON TO HVC IN WALL AT 20'0" BOUND ACCESS PANEL.
 6. 1/2" HATCH ON TO HVC IN FENCED WALL AT 20'0" BOUND ACCESS PANEL.
 7. 1/2" HATCH ON TO HVC IN FENCED WALL AT 20'0" BOUND ACCESS PANEL.
 8. 1/2" HATCH ON TO HVC IN FENCED WALL AT 20'0" BOUND ACCESS PANEL.
 100. 1/2" HATCH ON TO HVC IN FENCED WALL AT 20'0" BOUND ACCESS PANEL.

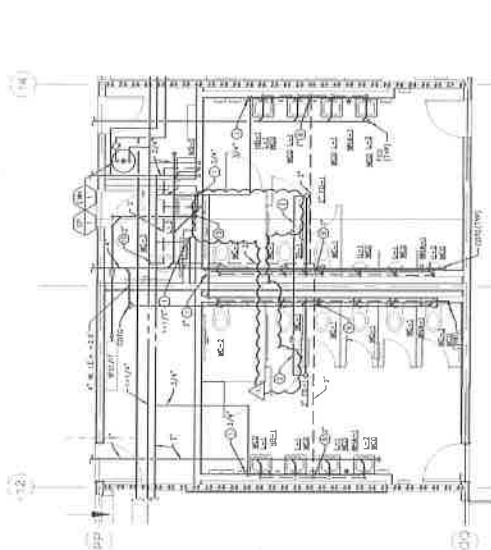

ENLARGED PLUMBING PLAN - A4, A5, A6
SCALE: 1/4" = 1'-0"

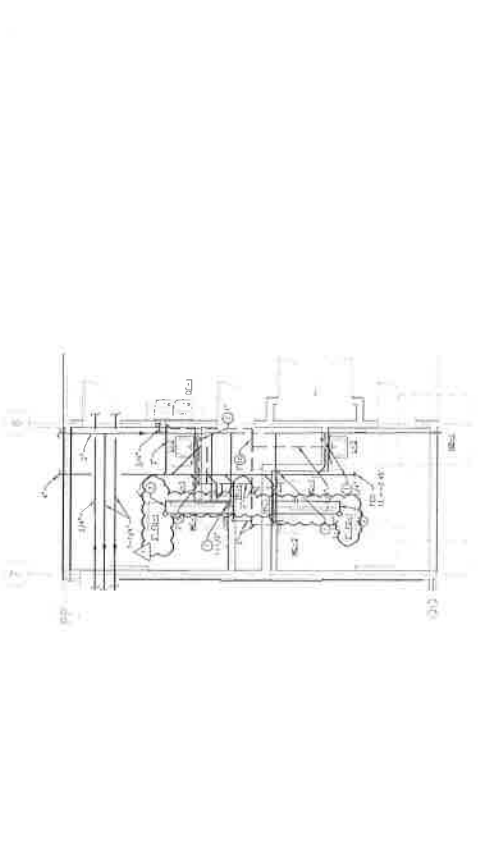

ENLARGED PLUMBING PLAN - A8, A9, A10
SCALE: 1/4" = 1'-0"

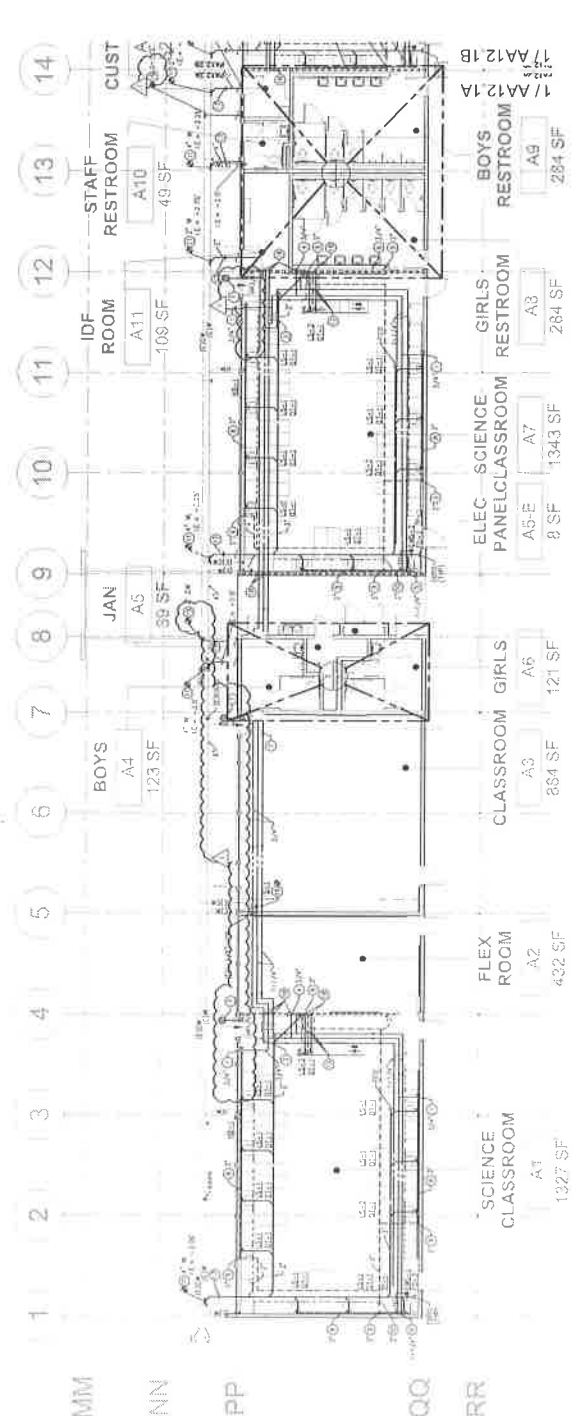

BUILDING A PLUMBING PLAN - AREA A
SCALE: 1/4" = 1'-0"



OWNER: RAVENSWOOD CITY SCHOOL
DISTRICT
PROJECT NAME: RAVENSWOOD MS
REALIGNMENT PHASE 1
CLIENT ADDRESS: 2120 EUCLID AVENUE EAST PALO ALTO, CA 94303

tkisc
1100 CALLE DE LA UNIÓN
SAN JOSE, CALIFORNIA 95128
PH: 408.277.1400
FAX: 408.277.1401
WWW.TKISC.COM

IDENTIFICATION STAMP
DIVISION OF THE STATE BOARD
OF ARCHITECTURE
ARCHITECT'S SEAL
A8 01-117275

REVISIONS	DATE
1. DESCRIPTION	DATE
2. ADDENDUM # 1	DATE

DATE ISSUED: 1/2/20
PROJECT NO: 2017-01
SCALE: 1/4" = 1'-0"

SHEET NUMBER: PA12.2
SHEET TITLE:

BUILDING A
IMPROVEMENT
PLAN -
AREA A,
PLUMBING



ARCHITECT


REVISIONS	DESCRIPTION	DATE
1	ADDITION # 1	8/18/01
2		
3		
4		
100		

DATE ISSUED:	10/20/00
PROJECT NO:	2617-4
SCALE:	As Ind.


PA12.2

SHEET NUMBER	SHEET TITLE
--------------	-------------


- [illegible]

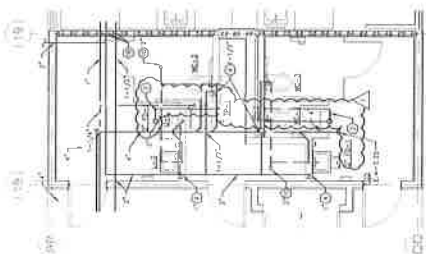

ENLARGED PLUMBING PLAN - A14, A15, A16
SCALE: 1/8"=1'-0"

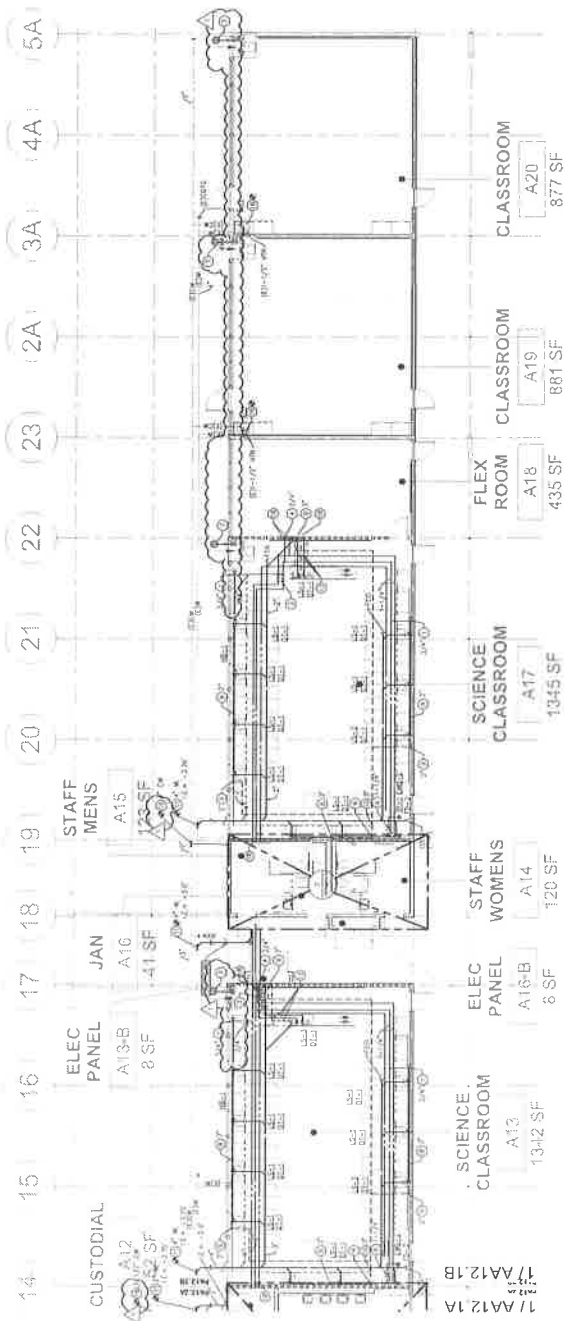

1
BUILDING A PLUMBING PLAN - AREA 8
SCALE: 1/8"=1'-0"

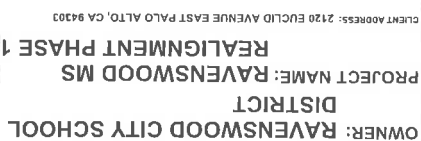

tk|sc
11000 Penn Plaza, Suite 100
Newark, California 94701
909.396.6140 www.tksc.com

IDENTIFICATION STAMP
DIVISION OF THE STATE ARCHIVES
OFFICE OF REGISTRATION
A# 01-117275

[illegible]

DATE ISSUED:	1500C
PROJECT NO:	2017A
SCALE:	BA 400C

4 SHEET NUMBER: PF12.2
SHEET TITLE:

BUILDING F
IMPROVEMENT
PLAN -
AREA A,
PLUMBING


SVA
ARCHITECT


1. The first step is to identify the problem. In this case, the problem is that the system is not working properly.

[illegible]

CONSTRUCTION NOTE:
FILL WITH WATER-PROOF FILL. ALL EXISTING OPENINGS &
PENETRATIONS WHERE PREVIOUS PAVING IS REMOVED REFER
TO ARCHITECTURAL PLANS FOR DETAILS.

SEE SHEET NO. 11
THESE NOTES DO NOT APPLY ON THIS SHEET

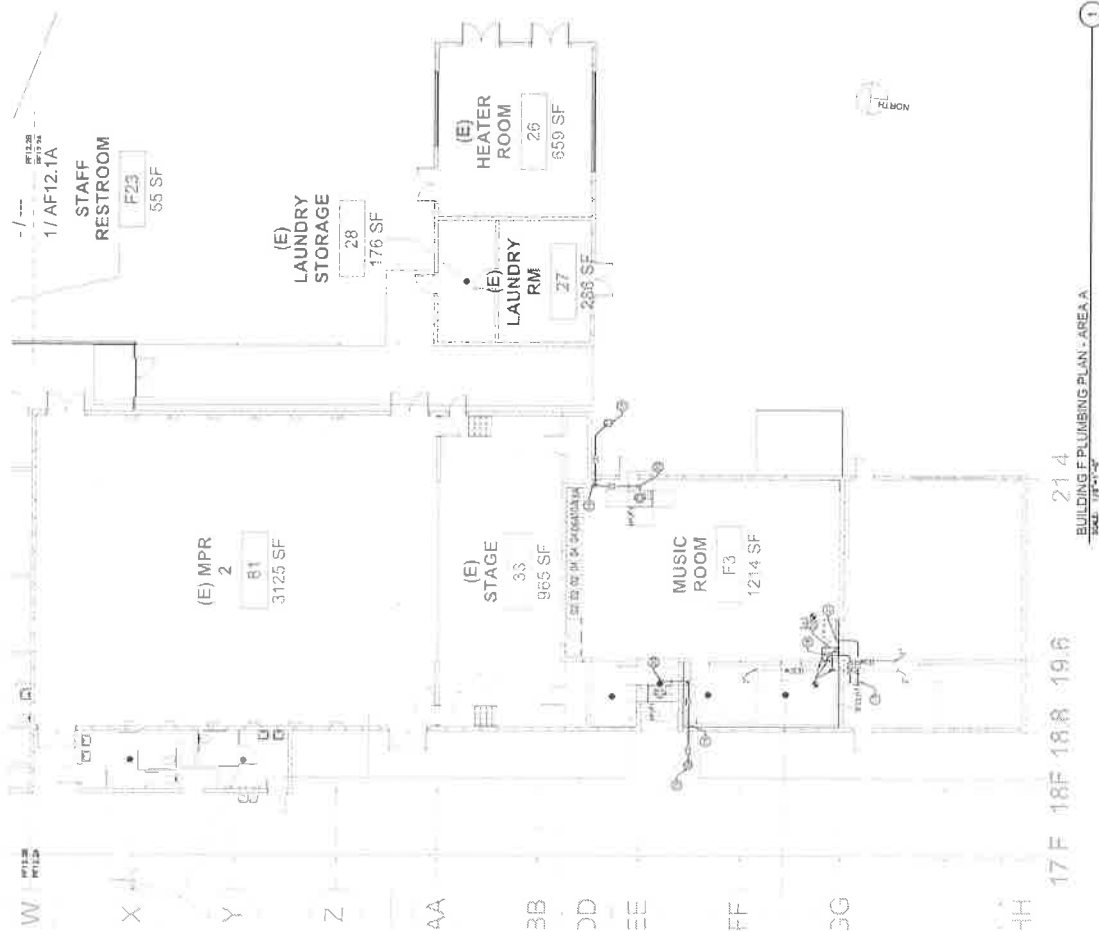

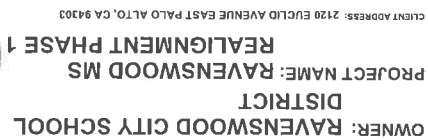

118 To Pacific Street, Suite 100
Pawcatuck, California 90242
800.228.1180 www.118.com

IDENTIFICATION STAMP
DIVISION OF THE STATE ARCHITECT
OFFICE OF REGULATION SERVICES
A# 01-117275

DATE	PLS	SS
REVISIONS:	DESCRIPTION	DATE
1	INITIALS	5/5/2015
2		
3		
4		
100		

DATE ISSUED:	10/30/17
PROJECT NO:	2017-41
SCALE:	AS SHOWN

SHEET NUMBER: PF12.2

BUILDING F
IMPROVEMENT
PLAN -
AREA B,
PLUMBING


SVA
ARCHITECT

$\log_{10} \text{PM}_{10} = -0.0007 \times \text{PM}_{10} + 6.89$

[illegible]

CONSTRUCTION NOTE
 1. ALL EXISTING OPENINGS &
 PENETRATIONS WHERE PREVIOUS PAVING IS REMOVED
 SHALL BE RECONSTRUCTED TO MEET ARCHITECTURAL PLANS FOR DETAILS.

REMARKS
 SEE SHEET 101
 ALL NOTES DO NOT APPLY ON THIS SHEET

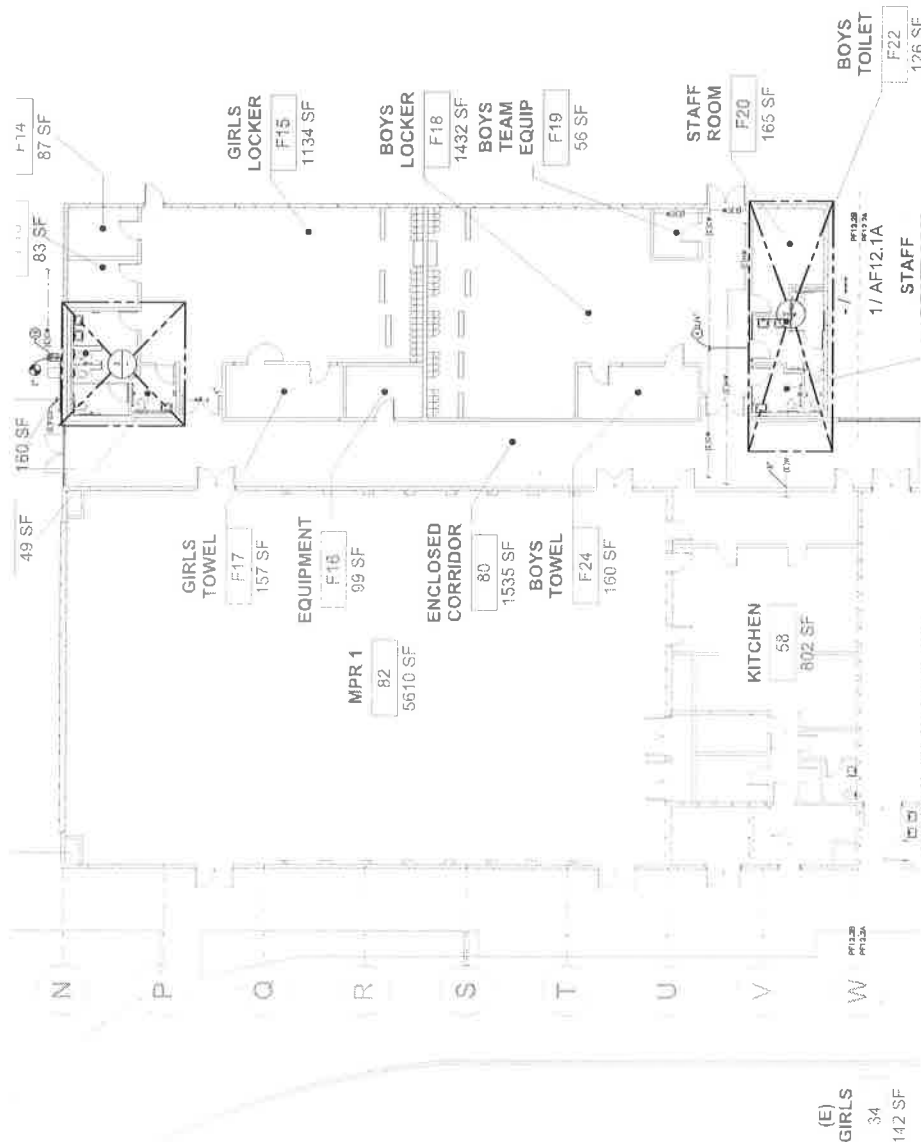

BUILDING F PLUMBING PLAN - AREA B

©

100



OWNER: RAVENSWOOD CITY SCHOOL DISTRICT
PROJECT NAME: RAVENSWOOD MS REALIGNMENT PHASE 1
CLIENT ADDRESS: 2120 EUCLID AVENUE EAST PALO ALTO, CA 94303



IDENTIFICATION STAMP
STATE OF CALIFORNIA
OFFICE OF REGULATION & SAFETY
AA 01-117275
AC... FS... SS...
DATE

REVISIONS	DESCRIPTION	DATE
1	ADDendum # 1	12/15/2018
2	ADDendum # 2	12/15/2018
3	ADDendum # 3	12/15/2018
4	ADDendum # 4	12/15/2018
5	ADDendum # 5	12/15/2018
6	ADDendum # 6	12/15/2018
7	ADDendum # 7	12/15/2018
8	ADDendum # 8	12/15/2018
9	ADDendum # 9	12/15/2018
10	ADDendum # 10	12/15/2018
11	ADDendum # 11	12/15/2018
12	ADDendum # 12	12/15/2018
13	ADDendum # 13	12/15/2018
14	ADDendum # 14	12/15/2018
15	ADDendum # 15	12/15/2018
16	ADDendum # 16	12/15/2018
17	ADDendum # 17	12/15/2018
18	ADDendum # 18	12/15/2018
19	ADDendum # 19	12/15/2018
20	ADDendum # 20	12/15/2018

DATE ISSUED: 12/15/2018
PROJECT NO: 10000
SCALE: AS SHOWN
SHEET NUMBER: P50
SHEET TITLE: PLUMBING DETAILS

PLUMBING DETAILS



<p>1</p> <p>GAS WATER HEATER</p> <p>NOTE: GAS WATER HEATER SHALL BE INSTALLED IN A VENTILATED SPACE.</p>	<p>2</p> <p>BACKING DETAIL</p>	<p>3</p> <p>CIRCULATION PUMP WIRING</p>
<p>4</p> <p>DILUTION TRAP</p>	<p>5</p> <p>INSTRUCTOR TABLE PIPING DIAGRAM</p>	<p>6</p> <p>INSTANTANEOUS WATER HEATER</p>
<p>7</p> <p>CONDENSATE DRAIN TO TAILPIECE</p>	<p>8</p> <p>CONDENSATE DRAIN TRAP @ CEILING FC UNIT</p>	<p>9</p> <p>CONDENSATE DRAIN TRAP</p>
<p>10</p> <p>CLEAN OUT / SOV IN CONCRETE YARD BOX</p>	<p>11</p> <p>DRYWELL DETAIL</p>	<p>12</p> <p>WALL PENETRATION DETAIL</p>